20' - 0"

32' - 0"





34' - 3 1/2"

21' - 8 1/2"

SIDE SETBACK

PROPOSED ADDITION

# **VICINITY MAP**

# **PROJECT DATA**

EMAIL:STEVE.JOO@HOTMAIL.COM

SITE ADDRESS: 8244 SE 30TH ST, MERCER ISLAND, WA 98040 PARCEL: 545230-0816 PROPERTY OWNER: TAE PARK PHONE NUMBER: 206-257-8380 EMAIL: TIMPARK1215@GMAIL.COM APPLICANT:STEVE JOO PHONE NUMBER: 206-306-6738

**LOT SIZE**: 13,200 SQ. FT.

### **LEGAL DESCRIPTION:**

MERCER PARK ADD E 30 FT OF 11 & ALL 12-13 LESS N 100 FT & 18-19 & E 30 FT OF 20 PLat Block: 7 Plat Lot: POR

### **LOT ZONING: R-9.6**

MAXIMUM LOT COVERAGE( BUILDING AND DRIVING SURFACES): 40% (LOT SLOPE LESS THAN 15%) MAXIMUM GROSS FLOOR ARÉA: 40% MAXIMUM BUILDING HEIGHT: 30 FEET YARD REQUIREMENTS: FRONT 20 FEET, REAR 25 FEET, SUM OF SIDE YARDS = 17% OF LOT WIDTH = 110 X 0.17 = 18.7 FEET (FOR LOTS WITH A LOT WIDTH OF MORE THAN 90 FEET)
PARKING: 2 COVERED AND 1 UNCOVERED ( OVER 3,000 SQ. FT. GFA )

### **DRAWING INDEX**

A-1: SITE PLAN & TESC PLAN A-1A: PERSPECTIVE VIEWS A-2: EXISTING BASEMENT PLAN A-3: EXISTING 1ST FLOOR PLAN A-4 : PROPOSED BASEMENT PLAN A-5: PROPOSED 1ST FLOOR PLAN A-6 : FOUNDATION PLAN

A-7: 1ST FLOOR FRAMING PLAN A-8 : ROOF FRAMING PLAN A-9: BUILDING ELEVATIONS - SOUTH

A-11: BUILDING ELEVATIONS - NORTH A-12 : BUILDING ELEVATIONS - WEST

A-13: WALL SECTIONS A-14 : DETAILS A-15 : DETAILS

A-16: DETAILS

HVAC, PLUMBING, ELECTRICAL ARE **UNDER SEPARATE PERMITS** 

INSTALL OF A NFPA 72 MONITORED "CHAPTER 29" FIRE ALARM SYSTEM PER NFPA 72 AND CoMI STANDARDS. THIS REQUIRES A SEPARATE PERMIT

### LOT COVERAGE

ALL ROOVES( INCLUDING EAVES )	2,433 SQ. FT.
DRIVEWAY( ASPHALT )	1,820 SQ. FT.
COVERED PATIO( CONCRETE )	0 SQ. FT.
TOTAL	4,253 SQ. FT.
4,253 / 13,200 X 100 = 32.2% < MAX ALL	OWED 40.0%

### **HARDSCAPE**

UNCOVERED DECK	324 SQ. FT.	
UNCOVERED PATIO	0 SQ. FT.	
WALKWAY	150 SQ. FT.	
ROCKERY	148 SQ. FT.	
TOTAL	622 SQ. FT.	
622 / 13,200 X 100 = 4.7% < MAX ALLOWED 9%		

## GROSS FLOOR AREA ( SQUARE FOOTAGE )

		EXISTIN	NG		PROPOSED			
	FINISHED AREA	UNFINISHED	GARAGE	SUB- TOTAL	FINISHED AREA	UNFINISHED	GARAGE	SUB- TOTAL
1ST FLOOR	1,510			1,510	2,008			2,008
BASEMENT	670	423	527	1,620	1,472		536	2,008
TOTAL	2,180	423	527	3,130	3,480		536	4,016
4,016 / 13,200 X 100 = 30.42% < MAX ALLOWED 40.0%								

#### **LOT SLOPE**

HIGHEST ELEVATION POINT: 210.3 FEET LOWEST ELEVATION POINT: 197.8 FEET HORIZONTAL DISTANCE BETWEEN HIGH AND LOW POINTS: 120 FEET

LOT SLOPE = (210.3 - 197.8) / 120 X 100 = **10.4**%

### LINETYPE LEGEND

	PROPERTY LINE
<del></del>	FILTER FABRIC FENCE
202.0'	EXISTING GRADE LINE

MIDPOINT ELEVATION	WALL SEGMENT LENGTH
A = 208.0 feet	a = 29.42 feet
B = 208.0 feet	b = 3.00 feet
C = 208.0 feet	c = 12.00 feet
D = 208.0 feet	d = 3.00 feet
E = 207.0 feet	e = 14.88 feet
F = 203.6 feet	f = 36.46 feet
G = 201.2 feet	g = 34.29 feet
H = 201.2 feet	h = 2.00 feet
I = 201.2 feet	i = 22.00 feet
J = 202.6 feet	j = 34.46 feet

= 204.04 feet

#### **AVERAGE BUILDING ELEVATION (ABE)**

201.2 feet	h = 2.00 feet
201.2 feet	i = 22.00 feet
202.6 feet	j = 34.46 feet
(208.0)(3.00)+(207.0 (201.2)(34.29)+(201 (202.6)(34.46) /	8.0)(3.00)+(208.0)(12.00)+ 0)(14.88)+(203.6)(36.46)+ .2)(2.00)+(201.2)(22.00)+ 00 + 3.00 + 14.88 + 36.46 + 00 + 34.46 )

# - EXISTING GRASS -EXISTING TREE TO REMAIN, TYPICAL ALL TREES IN THE PROPERTY - FILTER FABRIC FENCE **-200.0'-**PROPOSED ADDITION **-202.0'**-EXISTING HOUSE TO REMAIN (DARK GREY HATCHED) **-204.0'**-DOWNSPOUT(TYP) **—206.0**' PROPOSED ADDTITION (1ST FLOOR) EXISTING DRIVEWAY (ASPHALT) PROPOSED -WALKWAY (PAVER) EXISTING GRASS -

N 90.00'00" W 110.0'

SE 30TH ST

12' - 0"

14' - 10 1/2"

21' - 8 1/2"

SITE PLAN PROPOSED

SITE PLAN &

TESC PLAN

**TAE PARK** 8244 SE 30TH ST

ARCHITECT: **STEVE JOO** 206-306-6738

**SUNG CHO** 206-235-8886

**CIVIL ENGINEER:** 

cobaltgeo@gmail.com

MERCER ISLAND WA 98040

steve.joo@hotmail.com STRUCTURAL ENGINEER:

sung.cho@cs2engineers.com

**TANDEM ENGINEERING** tanddemengineering@outlook.com

GEOTECH ENGINEER:
COBALT GEOSCIENCES, LLC

PARK'S

RESIDENCE

**ADDITION** 

8244 SE 30TH ST MERCER ISLAND WA

REGISTERED

SEKWANG JOO

STATE OF WASHINGTON

EXPIRES 04 / 10 / 2023

MARK DATE DESCRIPTION

**A-1** 

DRAWN BY:



**SOUTHWEST VIEW** 



**NORTHEAST VIEW** 



**SOUTHEAST VIEW** 



**NORTHWEST VIEW** 

TAE PARK 8244 SE 30TH ST MERCER ISLAND WA 98040

ARCHITECT: STEVE JOO 206-306-6738 steve.joo@hotmail.com

STRUCTURAL ENGINEER: SUNG CHO 206-235-8886 sung.cho@cs2engineers.com

CIVIL ENGINEER:

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tanddemengineering@outlook.com

GEOTECH ENGINEER:
COBALT GEOSCIENCES, LLC
cobaltgeo@gmail.com

PARK'S

**ADDITION** 

RESIDENCE

8244 SE 30TH ST MERCER ISLAND WA 98040

STATE OF WASHINGTON EXPIRES 04 / 10 / 2023

MARK DATE DESCRIPTION DRAWN BY:

02/05/23

**PERSPECTIVE VIEWS** 


A-1A


#### NOTE FOR EXISTING CONDITION


THE CONSTRUCTION DOCUMENTS REPRESENTED HEREIN ARE BASED ON NON-INVASIVE SITE OBSERVATION OF THE EXISTING STRUCTURAL CONDITIONS OF THE PROPOSED PROJECT. AS A RESULT, IN CERTAIN INSTANCES, DESIGN ASSUMPTIONS WERE USED TO FORMULATE THE COMPATIBILITY OF THE NEW CONSTRUCTION WITH THE EXISTING STRUCTURAL ELEMENTS. DURING THE COURSE OF CONSTRUCTION, IT IS POSSIBLE THAT CONDITIONS MAY BE ENCOUNTERED THAT DO NOT COINCIDE WITH THE DESIGN ASSUMPTIONS AND MAY REQUIRE FURTHER STRUCTURAL REVIEW TO DETERMINE ADEQUACY. THE BUILDER SHALL BE OBSERVANT OF THESE CONDITIONS AND IMMEDIATELY REPORT ANY DISCREPANCIES TO THE ARCHITECT PRIOR TO PROCEEDING FURTHER WITH THE WORK.

#### **GENERAL NOTES**

- VERIFY IN THE FIELD ALL DIMENSIONS OF EXISTING CONDITION
- CONSTRUCTION TO COMPLY WITH THE 2018 IRC
- NEW 2X6 EXTERIOR STUD WALLS @ 16" O.C. STACKED FRAMED
- NEW 2X4 INTERIOR STUD WALLS @ 16" O.C. UNLESS NOTED OTHERWISE - BEARING AND HEADERS TO BE 6X8 #2 DF OR 4X10 #2 DF FURRED-OUT
- FIREBLOCK ALL PLUMBING PENETRATIONS
- PROVIDE SOLID BLOCKING OVER BEAMS & BEARING WALLS
- ALL HANGER TO BE SIMPSON OR EQUAL - BEDROOMS TO HAVE AT LEAST ONE OPERABLE WINDOW NET CLEAR OPENING OF 5.7 SQ. FT. MIN. WITH A NET CLEAR OPENING HT. OF 24" MIN. AND NET CLEAR OPENING WIDTH OF 20" MIN. AND A FINISHED SILL HEIGHT OF NOT MORE THAN
- 44" ABOVE FINISH FLOOR. - FIREPLACES AND STOVES MUST BE D.O.E. APPROVED AND BE TESTED, CERTIFIED & LABELED AS SUITABLE FOR USE DURING A FIRST STAGE BURN BAN - ALL LUMBER EXPOSED TO WEATHER OR CONCRETE TO BE PRESSURE TRESTED OR CEDAR

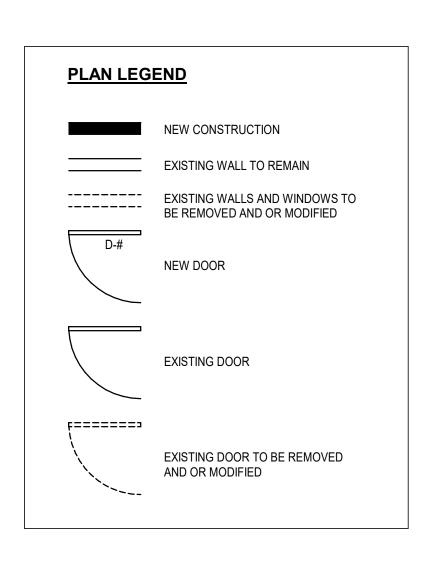

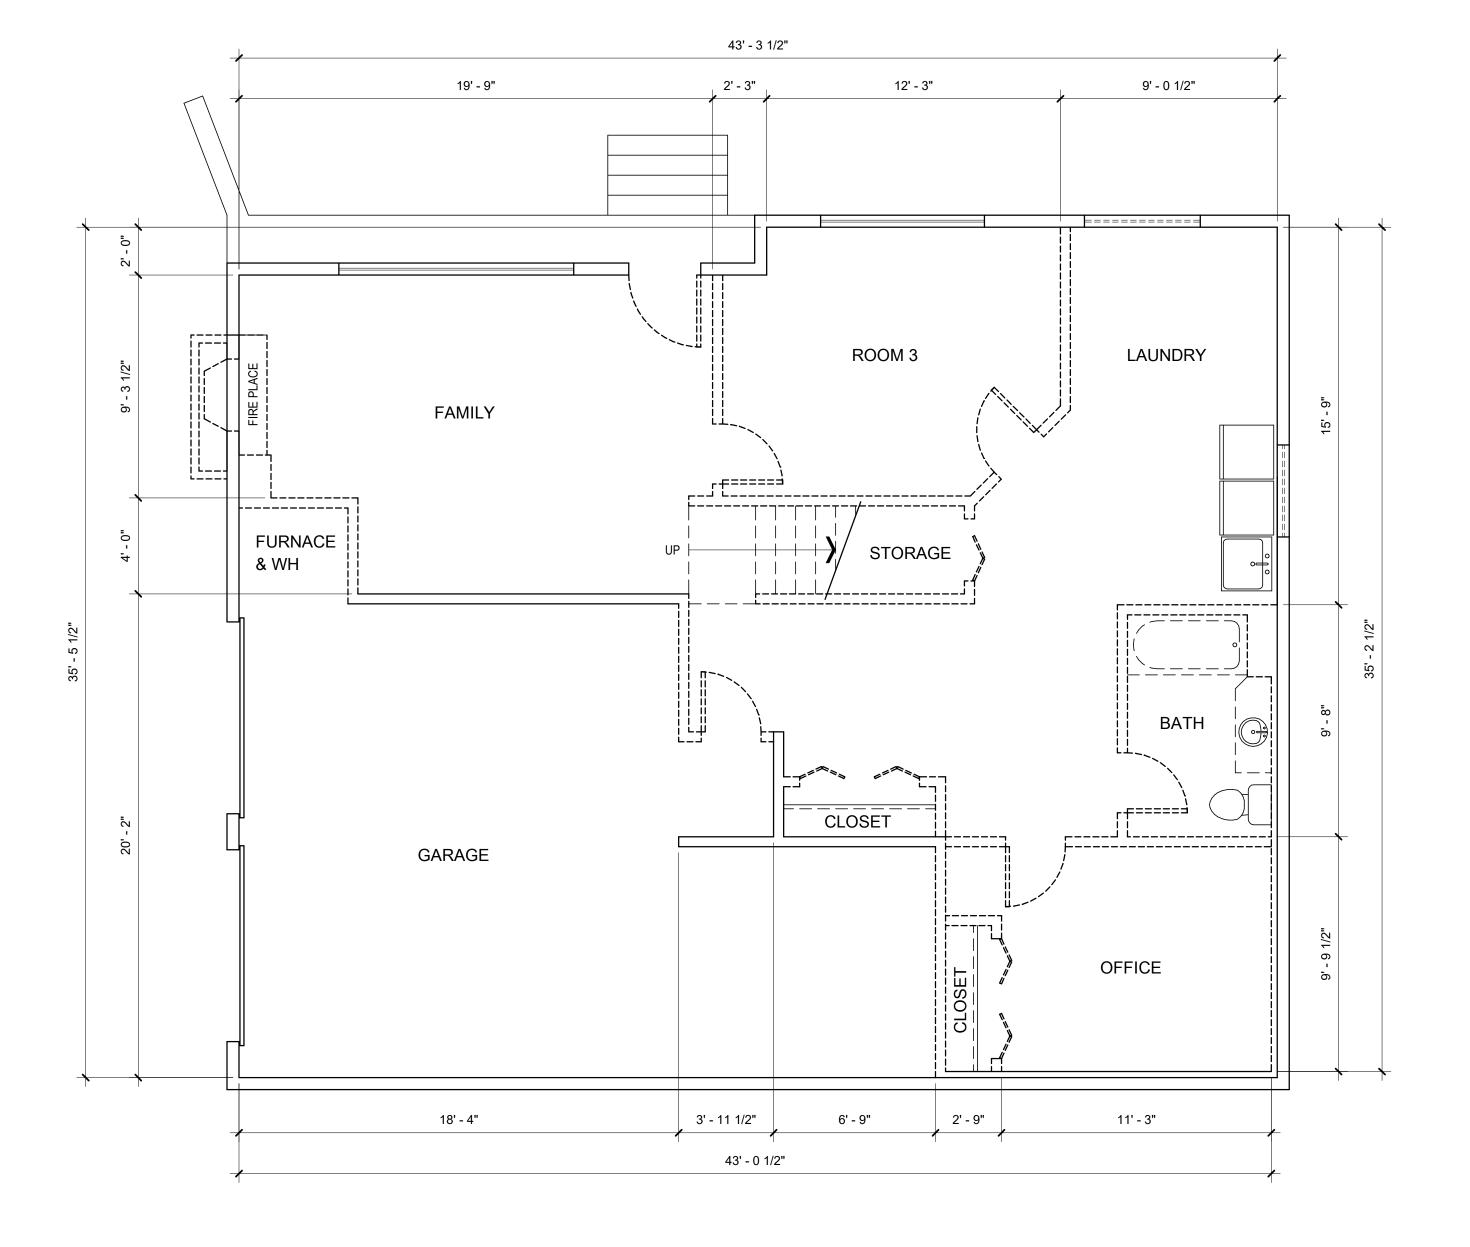

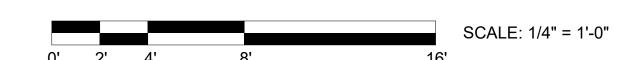



OWNER: **TAE PARK** 8244 SE 30TH ST

MERCER ISLAND WA 98040

ARCHITECT: STEVE JOO 206-306-6738 steve.joo@hotmail.com

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**CIVIL ENGINEER:** TANDEM ENGINEERING

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tanddemengineering@outlook.com **GEOTECH ENGINEER:** COBALT GEOSCIENCES, LLC

## PARK'S RESIDENCE **ADDITION**

8244 SE 30TH ST MERCER ISLAND WA 98040

SEKWANG JOO STATE OF WASHINGTON EXPIRES 04 / 10 / 2023

ISSUE

ISSUE	ISSUE						
MARK	DATE	DESCRIPTION					
DRAWN BY:		PROJ. ARCH.:					

12/17/2016


**EXISTING** BASEMENT PLAN


#### **NOTE FOR EXISTING CONDITION**


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#### **GENERAL NOTES**

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- CONSTRUCTION TO COMPLY WITH THE 2018 IRC
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- BEARING AND HEADERS TO BE 6X8 #2 DF OR 4X10 #2 DF FURRED-OUT
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- FIREPLACES AND STOVES MUST BE D.O.E. APPROVED AND BE TESTED, CERTIFIED & LABELED AS SUITABLE FOR USE DURING A FIRST STAGE BURN BAN - ALL LUMBER EXPOSED TO WEATHER OR CONCRETE TO BE PRESSURE TRESTED OR CEDAR



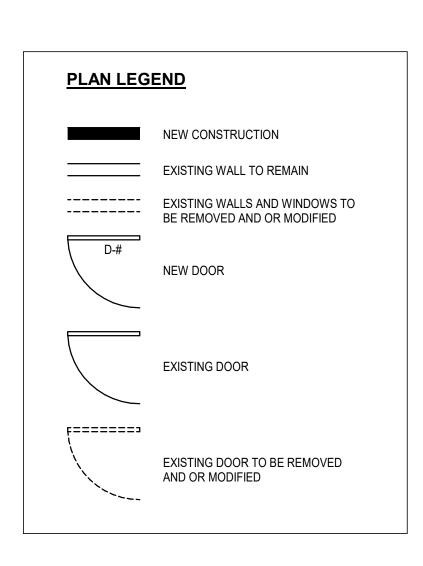

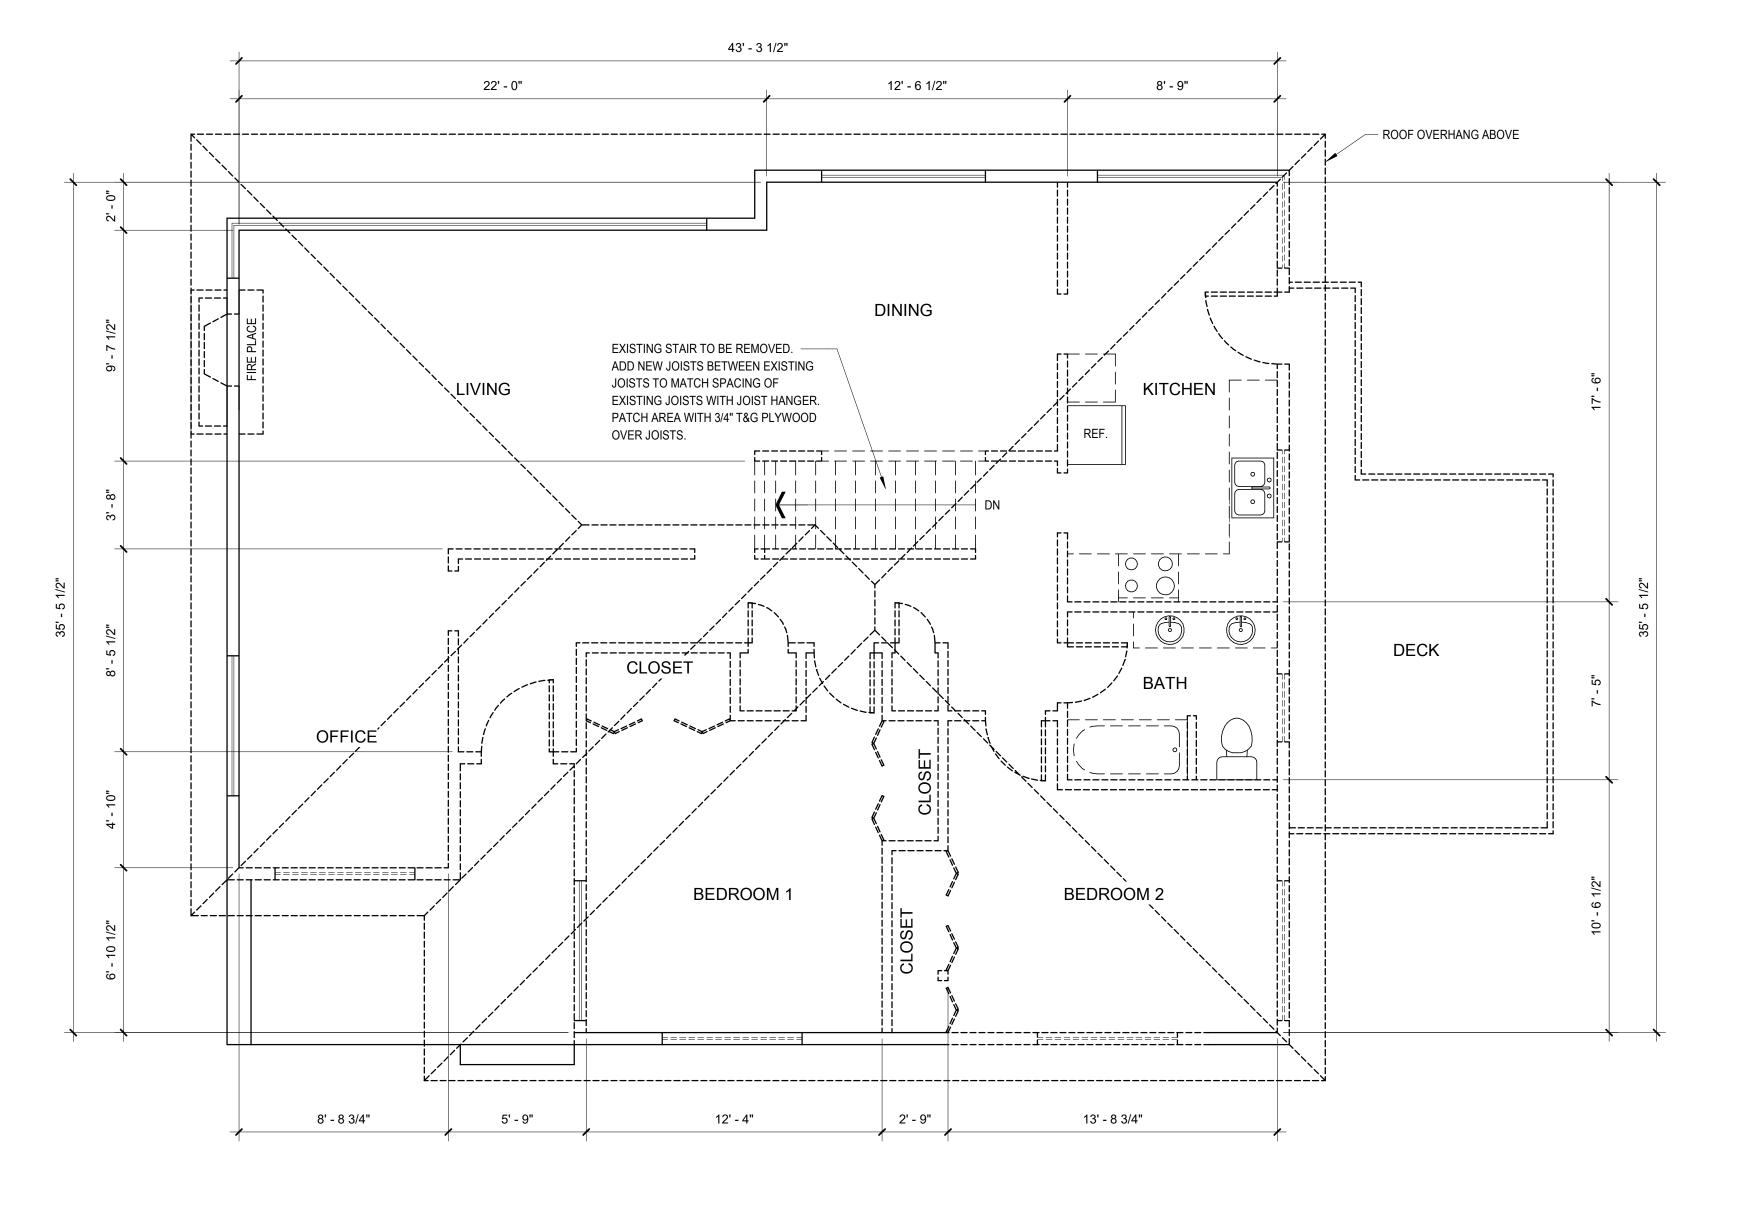

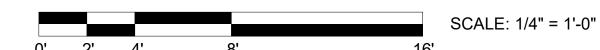

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MERCER ISLAND WA 98040

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**CIVIL ENGINEER:** TANDEM ENGINEERING tanddemengineering@outlook.com

**GEOTECH ENGINEER:** COBALT GEOSCIENCES, LLC cobaltgeo@gmail.com

### PARK'S **RESIDENCE ADDITION**

8244 SE 30TH ST MERCER ISLAND WA 98040

SEKWANG JOO STATE OF WASHINGTON

EXPIRES 04 / 10 / 2023

MARK DATE DESCRIPTION DRAWN BY:

12/26/21

**EXISTING 1ST** FLOOR PLAN

- VERIFY IN THE FIELD ALL DIMENSIONS OF EXISTING CONDITION

- CONSTRUCTION TO COMPLY WITH THE 2015 IRC - NEW 2X6 EXTERIOR STUD WALLS @ 16" O.C. STACKED FRAMED


- NEW 2X4 INTERIOR STUD WALLS @ 16" O.C. UNLESS NOTED OTHERWISE - BEARING AND HEADERS TO BE 6X8 #2 DF OR 4X10 #2 DF FURRED-OUT - FIREBLOCK ALL PLUMBING PENETRATIONS

- PROVIDE SOLID BLOCKING OVER BEAMS & BEARING WALLS
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- ALL LUMBER EXPOSED TO WEATHER OR CONCRETE TO BE PRESSURE TRESTED OR CEDAR

- BASEMENT CEILING TO MATCH EXISTING




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### **DOOR SCHEDULE**

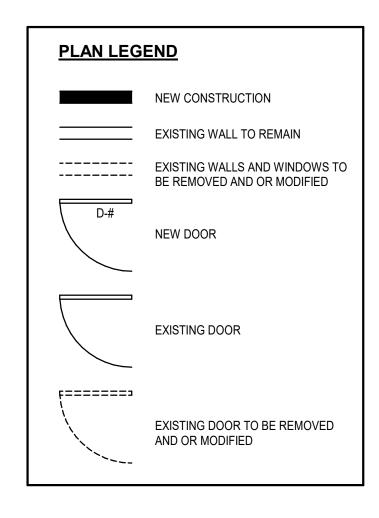DOOR	TYPE	5	SIZE	MATERIAL	DE.	TAIL	NOTE
NUMBER	111	WIDTH	HEIGHT	IVIATEINIAE	HEAD	JAMB	NOTE
D-01	SWING / SINGLE	3'-0"	6'-10"	WOOD + GLASS	2/A-16	3/A-16	W/ TRANSOM & SIDELIGHTS
D-02	SWING / SINGLE / PANEL	2'-8"	6'-8"	WOOD	2/A-16	3/A-16	
D-03	BARN / SINGLE / FLUSH	2'-6"	6'-8"	WOOD			
D-04	NOT USED						
D-05	BARN / SINGLE / FLUSH	2'-6"	6'-8"	WOOD			
D-06	BIFOLD / SINGLE / PANEL	2'-6"	6'-8"	WOOD	4/A-16	5/A-16	
D-07	NOT USED						
D-08	SWING / SINGLE / PANEL	2'-6"	6'-8"	WOOD	2/A-16	3/A-16	
D-09	SWING / SINGLE / PANEL	2'-6"	6'-8"	WOOD	2/A-16	3/A-16	
D-10	BIFOLD / DOUBLE / PANEL	4'-0"	6'-8"	WOOD	4/A-16	5/A-16	
D-11	SWING / DOUBLE	5'-0"	6'-8"	WOOD + GLASS	2/A-16	3/A-16	W/ TRANSOM
D-12	SWING / SINGLE / PANEL	2'-6"	6'-8"	WOOD	2/A-16	3/A-16	20 MIN FIRE RATING
D-13	SWING / DOUBLE	5'-0"	6'-8"	WOOD + GLASS	2/A-16	3/A-16	
D-14	SWING / SINGLE / PANEL	2'-6"	6'-8"	WOOD	2/A-16	3/A-16	
D-15	BIFOLD / DOUBLE / PANEL	4'-0"	6'-8"	WOOD	4/A-16	5/A-16	
D-16	BIFOLD / DOUBLE / PANEL	4'-0"	6'-8"	WOOD	4/A-16	5/A-16	
D-17	BIFOLD / DOUBLE / PANEL	4'-0"	6'-8"	WOOD	4/A-16	5/A-16	
D-18	BIFOLD / DOUBLE / PANEL	4'-0"	6'-8"	WOOD	4/A-16	5/A-16	
D-19	SWING / SINGLE / PANEL	2'-6"	6'-8"	WOOD	2/A-16	3/A-16	
D-20	SWING / SINGLE / PANEL	2'-6"	6'-8"	WOOD	2/A-16	3/A-16	
D-21	SWING / SINGLE / PANEL	2'-6"	6'-8"	WOOD	2/A-16	3/A-16	
D-22	SWING / SINGLE / PANEL	3'-0"	6'-8"	WOOD	2/A-16	3/A-16	



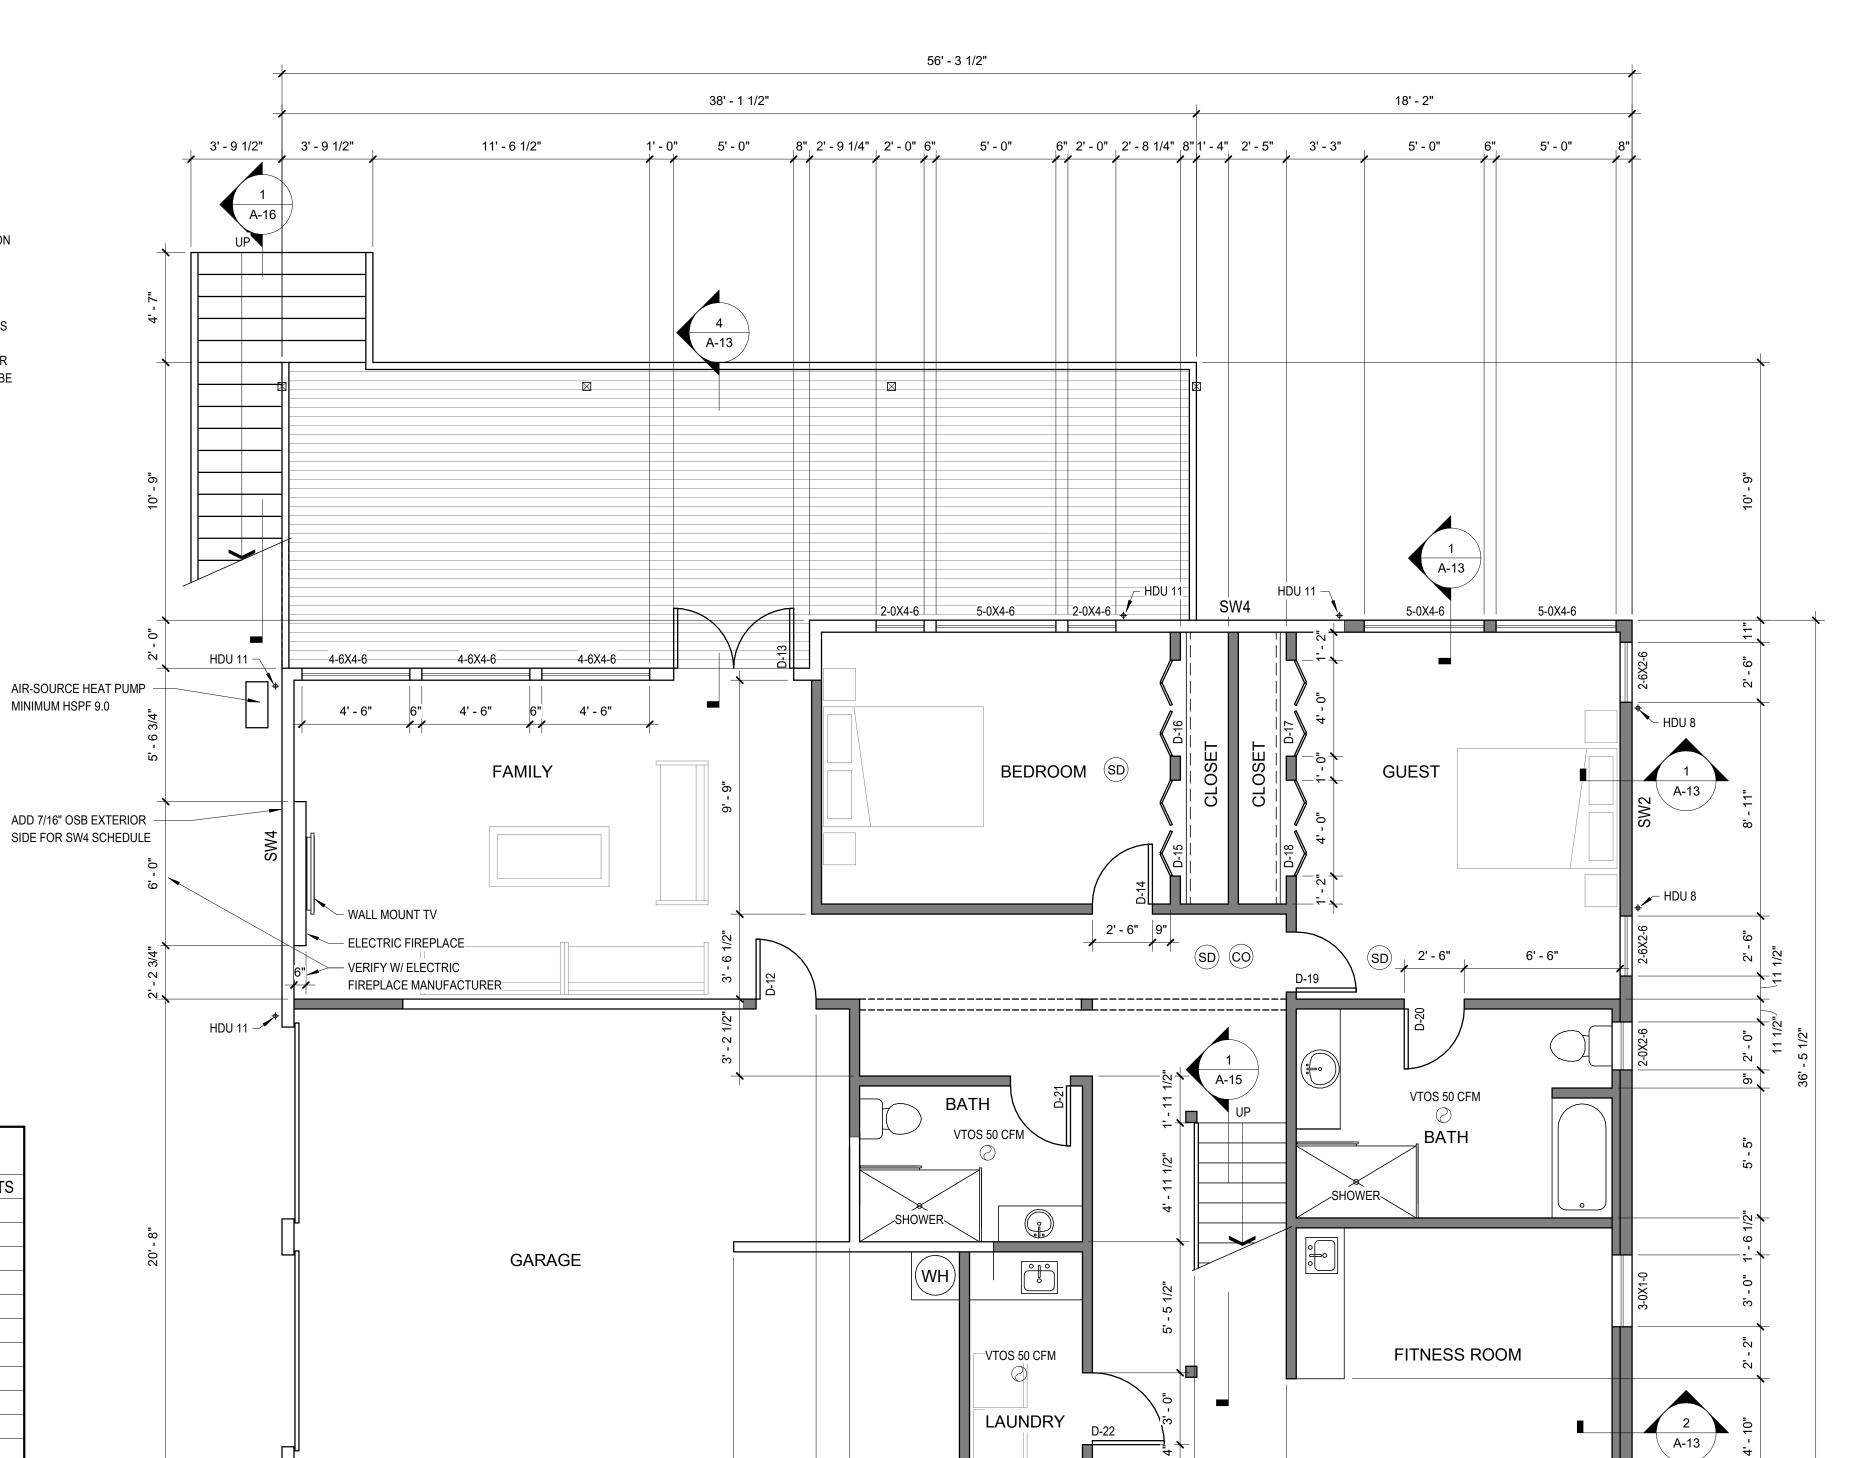

OWNER: **TAE PARK** 

**TAE PARK** 8244 SE 30TH ST MERCER ISLAND WA 98040

**ARCHITECT: STEVE JOO** 206-306-6738

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STRUCTURAL ENGINEER:

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GEOTECH ENGINEER:
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cobaltgeo@gmail.com

## PARK'S RESIDENCE ADDITION

8244 SE 30TH ST MERCER ISLAND WA 98040

REGISTERED ARCHITECT

SEKWANG JOO STATE OF WASHINGTON

EXPIRES 04 / 10 / 2023

MARK DATE DESCRIPTION

PROJ. ARCH.:

12/26/21

PROJ. NO.:

DWC

PROPOSED BASEMENT PLAN

DWG. **A-4** 

13' - 11"

18"x24" CRAWL SPACE ACCESS (INSULATE)

AT TOP OF FOUNDATION WALL

2' - 9 1/2" | 2' - 0" | 9" | 4' - 3"

18' - 4"

PROPOSED BASEMENT PLAN

:\Users\sjoo\Documents\Mercer Park 8244\_

1/4" = 1'

- VERIFY IN THE FIELD ALL DIMENSIONS OF EXISTING CONDITION - CONSTRUCTION TO COMPLY WITH THE 2015 IRC - NEW 2X6 EXTERIOR STUD WALLS @ 16" O.C. STACKED FRAMED - NEW 2X4 INTERIOR STUD WALLS @ 16" O.C. UNLESS NOTED OTHERWISE - BEARING AND HEADERS TO BE 6X8 #2 DF OR 4X10 #2 DF FURRED-OUT


- FIREBLOCK ALL PLUMBING PENETRATIONS - PROVIDE SOLID BLOCKING OVER BEAMS & BEARING WALLS

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- ALL LUMBER EXPOSED TO WEATHER OR CONCRETE TO BE PRESSURE TRESTED OR CEDAR

- 1ST FLOOR CEILING AT 12 FEET A.F.F. UNLESS NOTED OTHERWISE



#### NOTE FOR EXISTING CONDITION
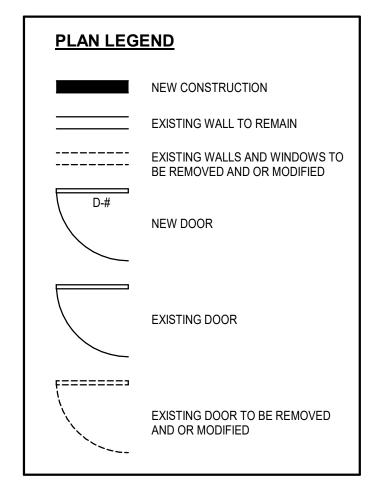
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#### SHEAR WALL SCHEDULE

OHEA	OHEAR WALL GOHLDOLL							
MARK	SHEATHING COMMON	STUDS AT ABUTTING PANEL	PANEL EDGE NAILING	RIM JOIST OR BLOCKING ATTACHMENT TO TOP PLATE		2X BOTTOM PLATE ATTACHMENT	SILL PLATE ATTACHMENT	
		EDGES*	**/***	SOLID RIM	TJI RIM	BOTTOM PLATE TO RIM JOIST BELOW**	ANCHOR BOLT TO CONCRETE ***	SILL PLATE AT FOUND.
SW1	7/16" OSB ONE SIDE	2X	8d @ 6" O.C.	A35 @ 24" O.C.	16d @ 6" O.C.	16d @ 6" O.C.	5/8" DIA. @ 48" O.C.	2X
SW2	7/16" OSB ONE SIDE	2X	8d @ 4" O.C.	A35 @ 15" O.C.	16d @ 4" O.C.	16d @ 4" O.C.	5/8" DIA. @ 32" O.C.	2X
SW3	7/16" OSB ONE SIDE	3X	8d @ 3" O.C.	A35 @ 12" O.C.	NA - USE SOLID RIM	16d @ 3" O.C.	5/8" DIA. @ 16" O.C.	2X
SW4	7/16" OSB ONE SIDE	3X	8d @ 2" O.C.	A35 @ 9" O.C.	NA - USE SOLID RIM	16d @ 2" O.C.	5/8" DIA. @ 12" O.C.	2X
				·	·	·		

INTERMEDIATE FRAMING TO BE 2x STUDS. TWO 2x STUDS MAY BE USED IN PLACE OF 3x STUDS; NAIL TOGETHER WITH BOTTOM

PLATE ATTACHMENT NAILING. \*\* 8d NAILS SHALL BE 0.131" DIA X 2 1/2" (COMMON). 16d NAILS SHALL BE 0.135" DIA X 3 1/2" (BOX).

\*\*\* USE ANCHOR BOLT WITH 7" MIN. EMBED OR EXPANSION BOLTS WITH 4" EMBED. AT ALL ANCHOR BOLTS USE 3"X3"X1/4" PLATE WASHERS (SIMPSON BP5/8-3 OR EQUAL)

\*\*\*\* TWO STUDS MINIMUM ARE REQUIRED AT EACH END OF SHEARWALLS. END STUD SHALL RECEIVE PANEL EDGE NAILING.

## WSEC - ENERGY EFFICIENCY CREDITS


SELECTED OPTIONS	DESCRIPTION	CREDIT
EFFICIENT BUILDING ENVELOPE 1.3	VERTICAL PENESTRATION U=0.28, FLOOR R=38	0.5
HIGH EFFICIENCY HVAC EQUIPMENT 3.4	DUCTLESS MINI-SPLIT HEAT PUMP SYSTEM	1.5
EFFICIENT WATER HEATING 5.3	GAS WATER HEATER W/ MINIMUM UEF OF 0.91	1.0

### WHOLE HOUSE FAN

	BATHROOM (3)	.25 w.g.	50 CFM	
	LAUNDRY	.25 w.g.	50 CFM	
	KITCHEN	.10 w.g.	100 CFM	
	BEDROOM (4)	.25 w.g.	50 CFM	
PROVIDE 150 CFM W.H.F. WITH A 24 HOUR T TO CONTROL EXHAUST FAN.				

INTERMITTENT AIR FLOW AT 50% RUN TIME.

VENTILATION PATH THROUGH UNDERCUT DOOR.

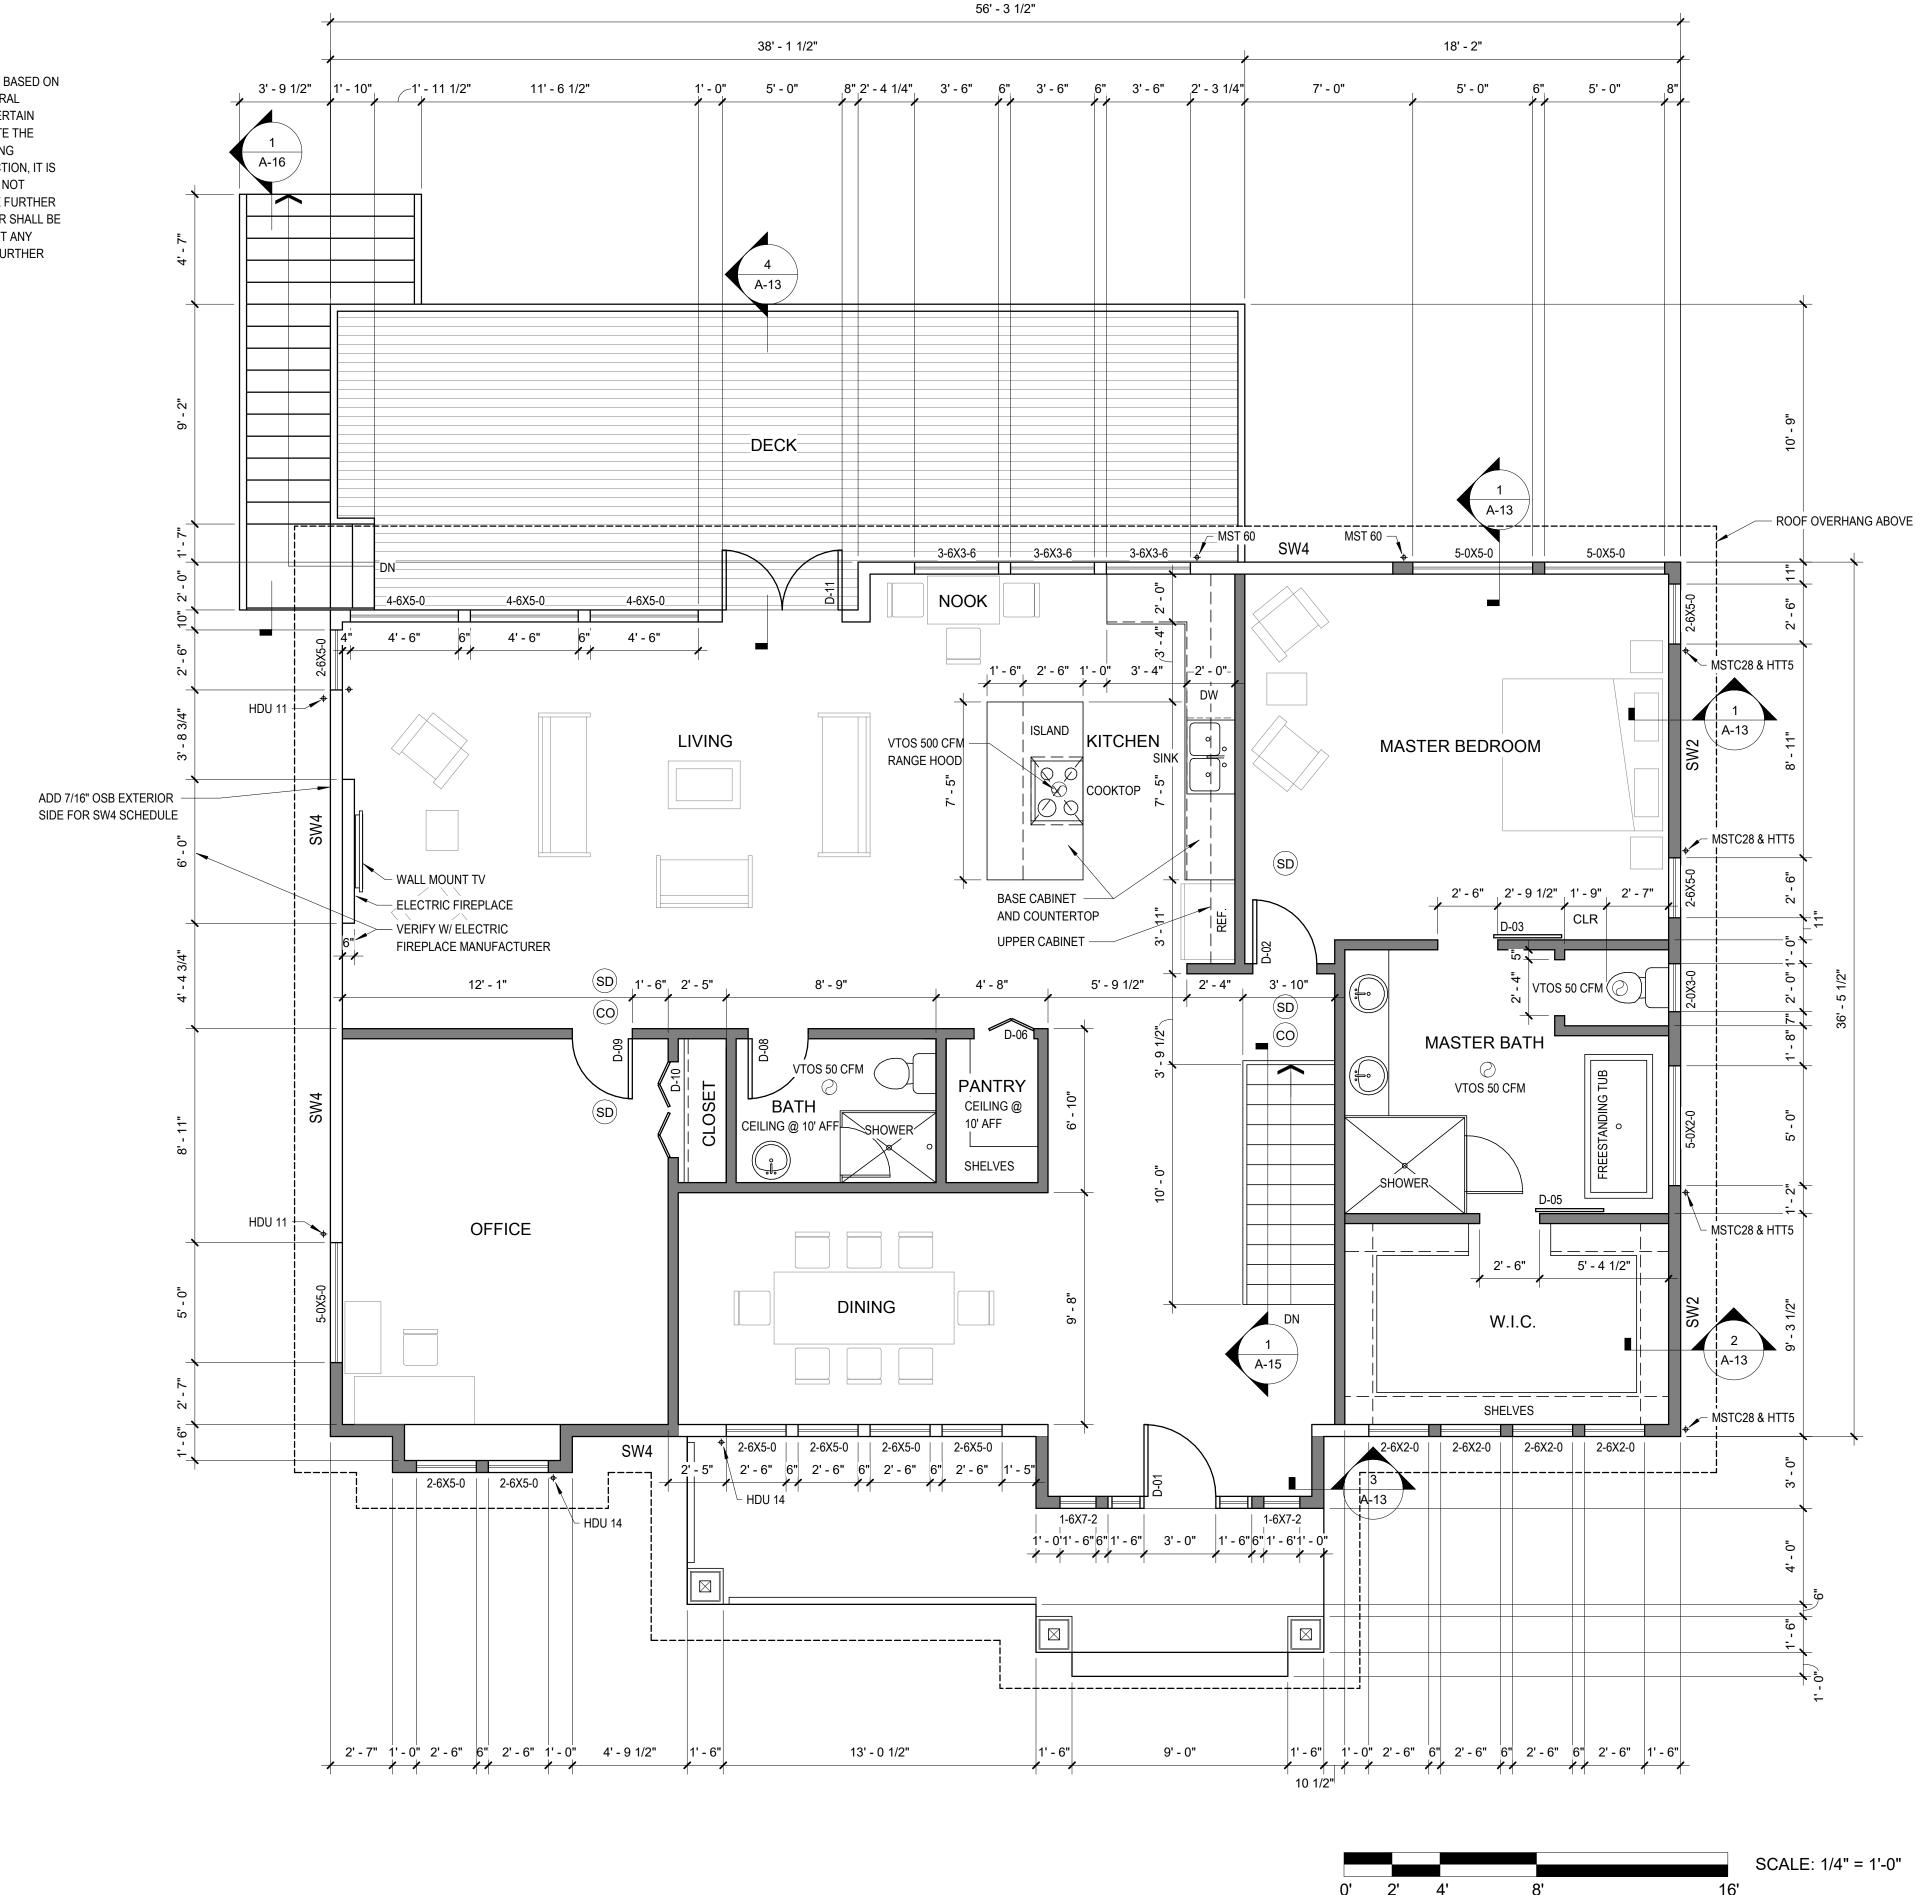

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## PARK'S RESIDENCE **ADDITION**

8244 SE 30TH ST MERCER ISLAND WA

REGISTERED ARCHITECT SEKWANG JOO STATE OF WASHINGTON

EXPIRES 04 / 10 / 2023

MARK DATE DESCRIPTION

ISSUE

DRAWN BY: PROJ. ARCH.:

12/17/2016

PROPOSED 1ST FLOOR PLAN

**A-5** 

PROPOSED 1ST FLOOR PLAN

 LIVE LOAD ROOF LIVE LOAD = 25 PSF (SNOW)\* FLOOR LIVE LOAD = 40 PSF DECK LIVE LOAD = 60 PSF

ROOF TRUSS DEAD LOAD = 10 PSF TOP CHORD + 5 PSF BOTTOM CHORD

3. WIND LOAD: WIND LOADS SHALL BE IN ACCORDANCE WITH THE IBC SECTION 1609 & ASCE 7-10, CHAPTER 26 THRU 31.

WIND IMPORTANCE FACTOR (IW) = 1.0, WIND EXPOSURE "C" BASIC WIND SPEED (V3S) = 98 mph TOPOGRAPHIC EFFECT (KZT) = 1.3

4. SEISMIC LOAD: EARTHQUAKE LOADS SHALL BE IN ACCORDANCE WITH THE BUILDING CODE (SECTION 1613) & ASCE 7-10, CHAPTER 12.

SEISMIC IMPORTANCE FACTOR (IE) = 1.0, SITE CLASS "D", R = 6.5 Ss = 1.395g, S1 = 0.486g,Sds = 1.116g, Sd1 = N/A SEISMIC DESIGN CATEGORY = "D"

1. FRAMING LUMBER SHALL BE KILN DRIED OR MC-19, AND GRADED AND MARKED IN CONFORMANCE WITH W.C.L.B. STANDARD GRADING RULES FOR WEST COAST LUMBER NO. 16. FURNISH TO THE FOLLOWING MINIMUM STANDARDS:

JOISTS & RAFTERS: HF#2 OR BETTER BEAMS: DF#2 OR BETTER STUDS, PLATES & MISC. FRAMING: HF STUD GRADE

2. STRUCTURAL WOOD PANEL SHEATHING (PLYWOOD) SHALL BE APA RATED SHEATHING WITH EXPOSURE 1 CLASSIFICATION.

ROOF SHEATHING SHALL BE 1/2" (NOMINAL) WITH SPAN RATING 24/0. FLOOR SHEATHING SHALL BE 3/4" (NOMINAL) WITH SPAN RATING 40/20. WALL SHEATHING SHALL BE 1/2" (NOMINAL) WITH SPAN RATING 24/0. REFER TO WOOD FRAMING NOTES BELOW FOR TYPICAL NAILING REQUIREMENTS.

3. ALL WOOD IN DIRECT CONTACT WITH CONCRETE OR MASONRY SHALL BE PRESSURE TREATED WITH AN APPROVED PRESERVATIVE OR (2) LAYERS OF ASPHALT IMPREGNATED BUILDING PAPER SHALL BE PROVIDED BETWEEN UNTREATED WOOD AND CONCRETE OR MASONRY.

4. ALL LUMBER EXPOSED TO WEATHER TO BE PRESSURE TREATED OR CEDAR.

5. TIMBER CONNECTORS CALLED OUT BY LETTERS AND NUMBERS SHALL BE "STRONG-TIE" BY SIMPSON COMPANY, AS SPECIFIED IN THEIR LATEST CATALOG. EQUIVALENT DEVICES BY OTHER MANUFACTURERS MAY BE SUBSTITUTED, PROVIDED THEY HAVE ICBO APPROVAL FOR EQUAL OR GREATER LOAD CAPACITIES. PROVIDE NUMBER AND SIZE OF FASTENERS AS SPECIFIED BY MANUFACTURER. CONNECTORS SHALL BE INSTALLED IN ACCORDANCE WITH THE MANUFACTURER'S RECOMMENDATIONS. WHERE CONNECTOR STRAPS CONNECT TWO MEMBERS, PLACE ONE-HALF OF THE NAILS OR BOLTS IN EACH MEMBER. ALL BOLTS IN WOOD MEMBERS SHALL CONFORM TO ASTM A307. PROVIDE WASHERS UNDER THE HEADS AND NUTS OF ALL BOLTS AND LAG SCREWS BEARING ON WOOD. UNLESS NOTED OTHERWISE, ALL NAILS SHALL BE COMMON. ALL SHIMS SHALL BE SEASONED AND DRIED AND THE SAME GRADE (MINIMUM) AS MEMBERS CONNECTED. ALL JOISTS SHALL BE CONNECTED TO FLUSH BEAMS WITH "U" SERIES JOIST HANGERS.

#### CAST-IN-PLACE CONCRETE:

1. CONCRETE SHALL BE MIXED, PROPORTIONED, CONVEYED AND PLACED IN ACCORDANCE WITH IBC AND ACI 301. CONCRETE SHALL ATTAIN A 28-DAY STRENGTH OF fc = 3,000 PSI AND MIX SHALL CONTAIN NOT LESS THAN 5 1/2 SACKS OF CEMENT PER CUBIC YARD AND SHALL BE PROPORTIONED TO PRODUCE A SLUMP OF 3" TO 5".

2. THE MINIMUM AMOUNTS OF CEMENTITIOUS MATERIAL MAY BE CHANGED IF A CONCRETE PERFORMANCE MIX IS SUBMITTED TO THE STRUCTURAL ENGINEER AND THE BUILDING DEPARTMENT FOR APPROVAL TWO WEEKS PRIOR TO PLACING ANY CONCRETE. THE PERFORMANCE MIX SHALL INCLUDE THE AMOUNTS OF CEMENT, FINE AND COARSE AGGREGATE, WATER AND ADMIXTURES, AS WELL AS THE WATER-CEMENT RATIO, SLUMP, CONCRETE YIELD AND SUBSTANTIATING STRENGTH DATA IN ACCORDANCE WITH ACI 318. REVIEW OF MIX SUBMITTALS BY THE ENGINEER OF RECORD INDICATES ONLY THAT INFORMATION PRESENTED CONFORMS GENERALLY WITH CONTRACT DOCUMENTS. CONTRACTOR OR SUPPLIER MAINTAINS FULL RESPONSIBILITY FOR SPECIFIED PERFORMANCE.

3. SLEEVES, OPENINGS, CONDUIT, AND OTHER EMBEDDED ITEMS NOT SHOWN ON THE STRUCTURAL DRAWINGS SHALL BE APPROVED BY THE PROJECT ARCHITECT/ENGINEER BEFORE POURING. CONDUITS EMBEDDED IN SLABS SHALL NOT BE LARGER IN OUTSIDE DIMENSION THAN ONE THIRD OF THE THICKNESS OF THE SLAB AND SHALL NOT BE SPACED CLOSER THAN THREE DIAMETERS ON CENTER.

4. WHERE NEW CONCRETE IS PLACED AGAINST EXISTING CONCRETE, THE EXISTING CONCRETE SURFACE SHALL BE CLEANED AND ROUGHENED TO A MINIMUM 1/4" AMPLITUDE. PROVIDE 3/4" CHAMFERS ON ALL EXPOSED CONCRETE EDGES, UNLESS NOTED OTHERWISE.

5. VERIFY ALL BLOCKOUTS WITH ARCHITECTURAL, MECHANICAL, ELECTRICAL, AND PLUMBING REQUIREMENTS.

#### REINFORCING STEEL:

1. REINFORCING STEEL SHALL CONFORM TO ASTM A615, INCLUDING S1, GRADE 60, FOR DEFORMED BARS AND ASTM A185 FOR SMOOTH WELDED WIRE FABRIC (WWF), UNLESS OTHERWISE NOTED. REINFORCING STEEL TO BE WELDED SHALL CONFORM TO ASTM A706. COLUMN SPIRALS SHALL BE PLAIN OR DEFORMED BARS CONFORMING TO ASTM A615, GRADE 60. REINFORCING STEEL SHALL BE SECURELY TIED IN PLACE WITH #16 ANNEALED IRON WIRE.

2. BARS IN SLABS SHALL BE SUPPORTED ON WELL-CURED CONCRETE BLOCKS OR APPROVED METAL CHAIRS, AS SPECIFIED BY THE CRSI MANUAL OF STANDARD PRACTICE, MSP-1. REINFORCING STEEL SHALL BE DETAILED IN ACCORDANCE WITH THE "ACI MANUAL OF STANDARD PRACTICE FOR DETAILING REINFORCED CONCRETE STRUCTURES," ACI 315. SHOP DRAWINGS SHALL INCLUDE ELEVATIONS OF ALL COLUMNS SHOWING BAR LOCATIONS. LAP ALL REINFORCING BARS AT SPLICES 36 DIAMETERS, WITH A MINIMUM LAP OF 18", EXCEPT AS NOTED.

3. CONCRETE PROTECTION (COVER) FOR REINFORCING STEEL SHALL BE AS FOLLOWS, UNLESS NOTED OTHERWISE:

CAST AGAINST EARTH...... 3 IN.

CONCRETE EXPOSED TO EARTH OR WEATHER: #6 AND LARGER ...... 2 IN. #5 AND SMALLER & WWF ....... 1 1/2 IN.

CONCRETE NOT EXPOSED TO EARTH OR WEATHER OR NOT CAST AGAINST THE

GROUND:: SLAB AND WALL ...... 3/4 IN. BEAMS AND COLUMNS ...... 1 1/2 IN.

### FOUNDATION NOTES:

-. CONCRETE TO BE 5 SACK F'c=3,000 PSI @ 28 DAYS

-. REINFORCING STEEL TO BE ASTM A-615 GRADE 40 OR BETTER

-. FOOTINGS TO REST ON 1,500 PSI UNDISTURBED SOIL (ASSUMED) -. MIN. CONCRETE COVERAGE OF STEEL TO BE:


3" CLEAR @ BOTTOM OF FOOTINGS

1 1/2" CLEAR @ SIDE OF WALLS -. ALL LUMBER IN CONTACT W/ CONCRETE TO BE PRESSURE TREATED

-. PROVIDE SOLID BLOCKING OVER SUPPORTS

-. ALL ROOF DRAIN DOWNSPOUTS SHALL EMPTY INTO A 4" TIGHTLINE THAT SHALL RUN THE PERIMETER OF THE FOUNDATION AND EMPTY IN AN APPROVED MANNER

-. FOOTINGS LOCATED INSIDE OF CRAWL SPACE WILL BE 8" BELOW GRADE. EXTERIOR FOOTINGS TO BE 18" MIN. BELOW GRADE, U.N.O.

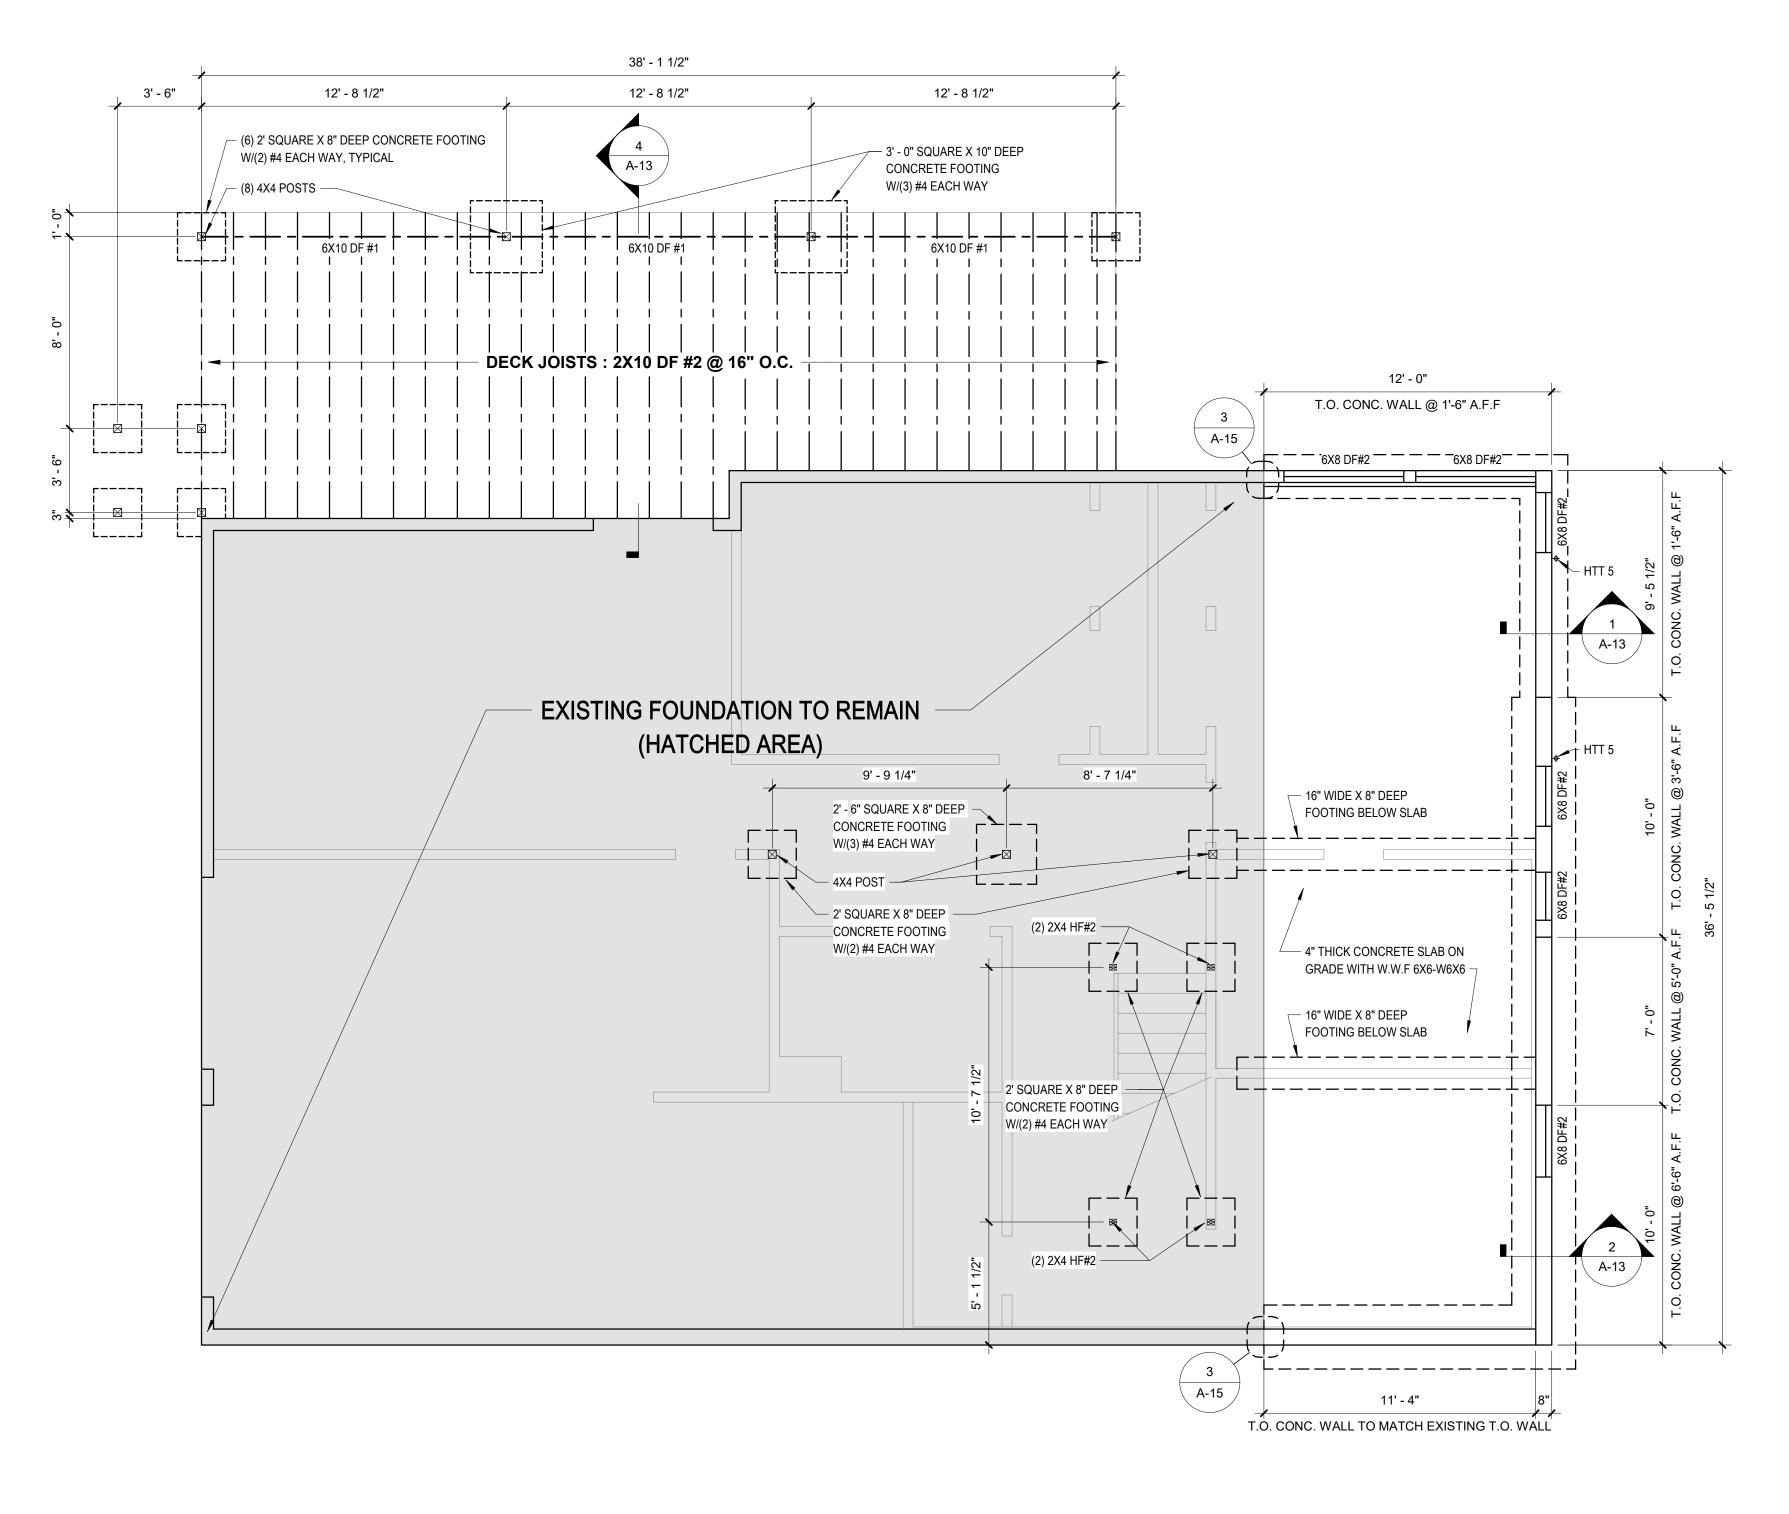



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**GEOTECH ENGINEER:** COBALT GEOSCIENCES, LLC cobaltgeo@gmail.com

PARK'S RESIDENCE **ADDITION** 

8244 SE 30TH ST MERCER ISLAND WA

REGISTERED ARCHITECT SEKWANG JOO STATE OF WASHINGTON EXPIRES 04 / 10 / 2023

ISSUE MARK DATE DESCRIPTION STRUCTURAL REVIEW 04/29/2017

DRAWN BY: PROJ. ARCH.:

3/15/2017

**FOUNDATION** 

**PLAN** 


FOUNDATION PLAN

- VERIFY IN THE FIELD ALL DIMENSIONS FOR EXISTING CONDITION - ALL HEADERS TO BE 6X8 DF#2 OR 4X10 DF#2 UNLESS NOTED OTHERWISE. - ALL LUMBER EXPOSED TO WEATHER TO BE PRESSURE TREATED OR CEDAR. - FIREBLOCK ALL VOIDS.

#### UNDER-FLOOR VENTILATION:

13" X 7" SCREENED VENT = 91 SQ. IN.

ENTRY PORCH AREA: 36 SQ. FT. X 144/150 = 34.56 SQ IN. X 1.2 (NET AREA) 41.47 / 91 = 0.46 VENT REQUIRED PROVIDE (1) 13" X 7" UNDER-FLOOR VENT IRC SECTION R408.2

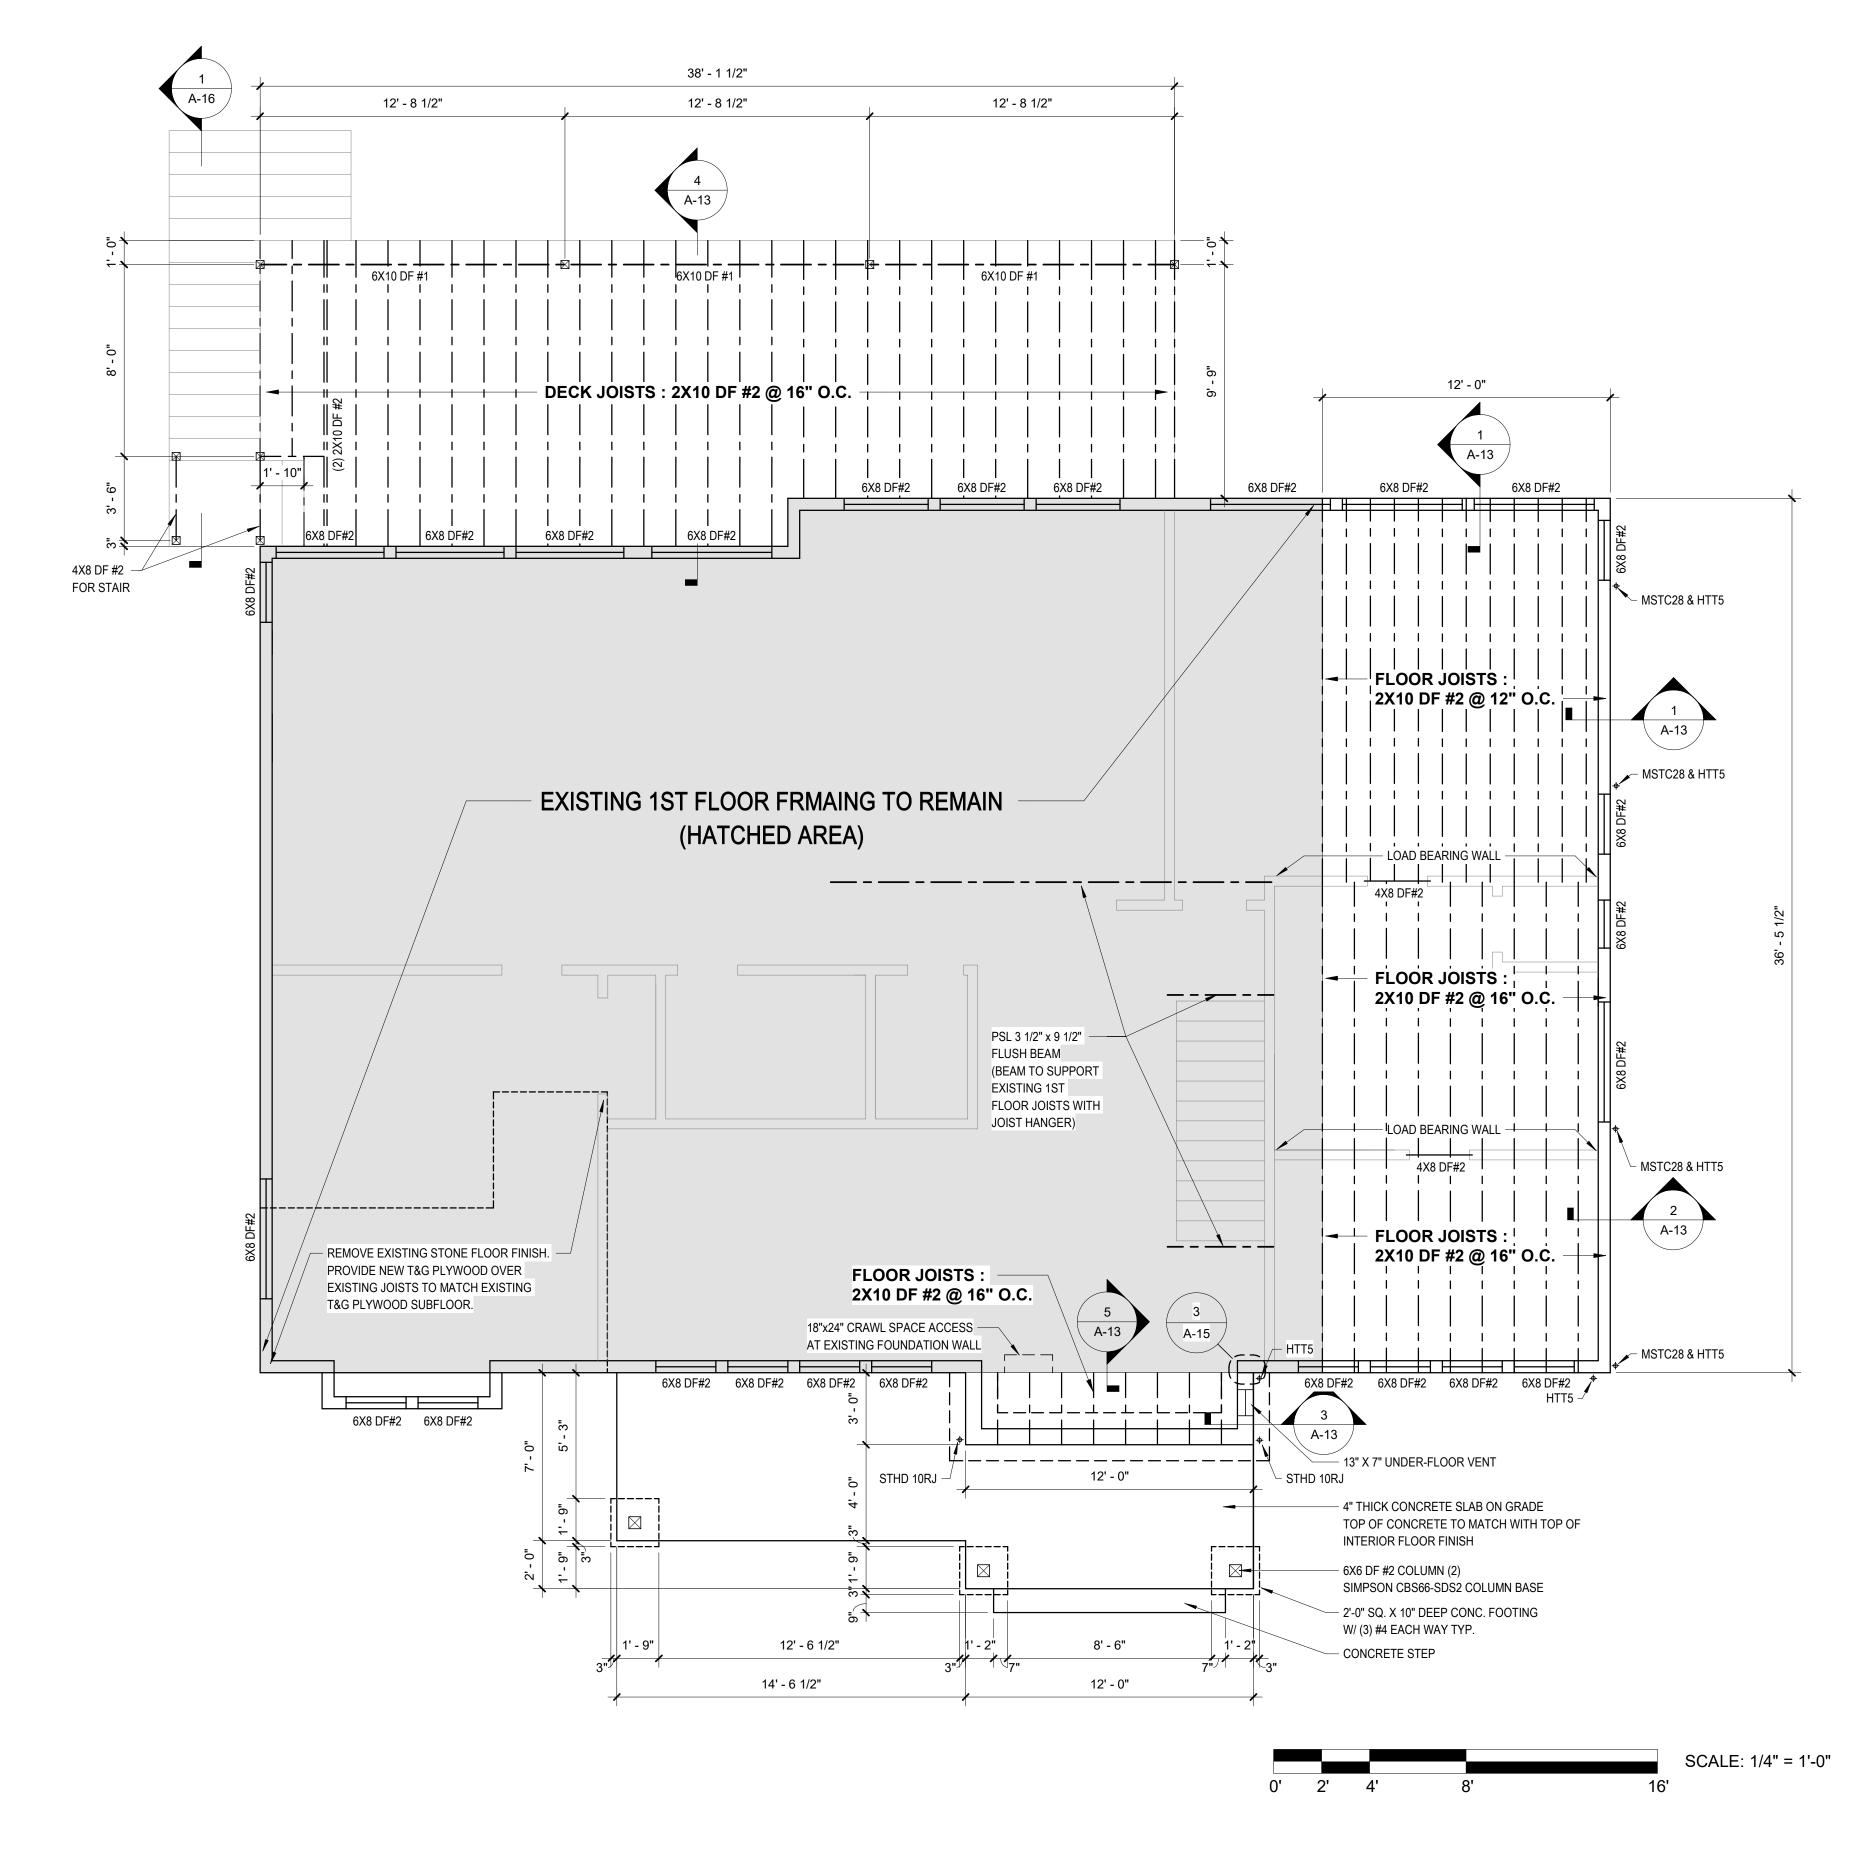

1ST FLOOR FRAMING PLAN

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### PARK'S **RESIDENCE ADDITION**

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REGISTERED SEKWANG JOO STATE OF WASHINGTON EXPIRES 04 / 10 / 2023

ISSUE MARK DATE DESCRIPTION STRUCTURAL REVIEW 04/29/2017 DRAWN BY: PROJ. ARCH.:

01/03/22

1ST FLOOR FRAMING PLAN

**GENERAL NOTES:** 

- VERIFY IN THE FIELD ALL DIMENSIONS FOR EXISTING CONDITION - ALL HEADERS TO BE 6X8 DF#2 OR 4X10 DF#2 UNLESS NOTED OTHERWISE. - ALL LUMBER EXPOSED TO WEATHER TO BE PRESSURE TREATED OR CEDAR. - SKYLIGHTS IN HEATED ENVELOP TO BE INSULATED PER WSEC. - MIN. 22"X30" ATTIC ACCESS W/ 36" MIN. HEAD ROOM. INSULATE AND WEATHERSTRIP. - FIREBLOCK ALL VOIDS.

TRUSS NOTES:

- SHALL HAVE MANUFACTURER'S STAMP. - SHALL BE INSTALLED AND BRACED PER MANUFACTURER'S INSTRUCTIONS. - WILL NOT BE FIELD ALTERED WITHOUT BUILDING DEPARTMENT APPROVAL OF THE ENGINEERING CALCULATIONS. - SHALL HAVE DESIGN DETAILS AND DRAWINGS ON SITE.

TRUSS HOLDDOWN:

SIMPSON H8 HURRICANE TIE-G90 GALVANIZED AT EACH TRUSS


**ROOF NOTES:** MATERIAL: COMPOSITE ROOFING


PITCH: 6:12 OVERHANG: SEE DIMENSIONS ON PLAN FASCIA: 1"X6" PRIMED AND PAINTED SPRUCE FASCIA BOARD,

1"X8" PRIMED AND PAINTED SPRUCE FASCIA BOARD AT GABLE

ATTIC VENTILATION:

2,592 SQ. FT.( NEW ATTIC SPACE ) X 144/300 = 1,244.2 SQ. IN.( REQUIRED NET AREA ) PROVIDE CONTINUOUS SOFFIT VENT 2"X(36' + 36' + 56' + 6' + 12' + 12' + 4') = 3,888 SQ. IN. PROVIDE (5) AF-50 ROOF JACKS = 250 SQ. IN. TOTAL 4,138 SQ. IN. PROVIDED IRC SECTION R806.2

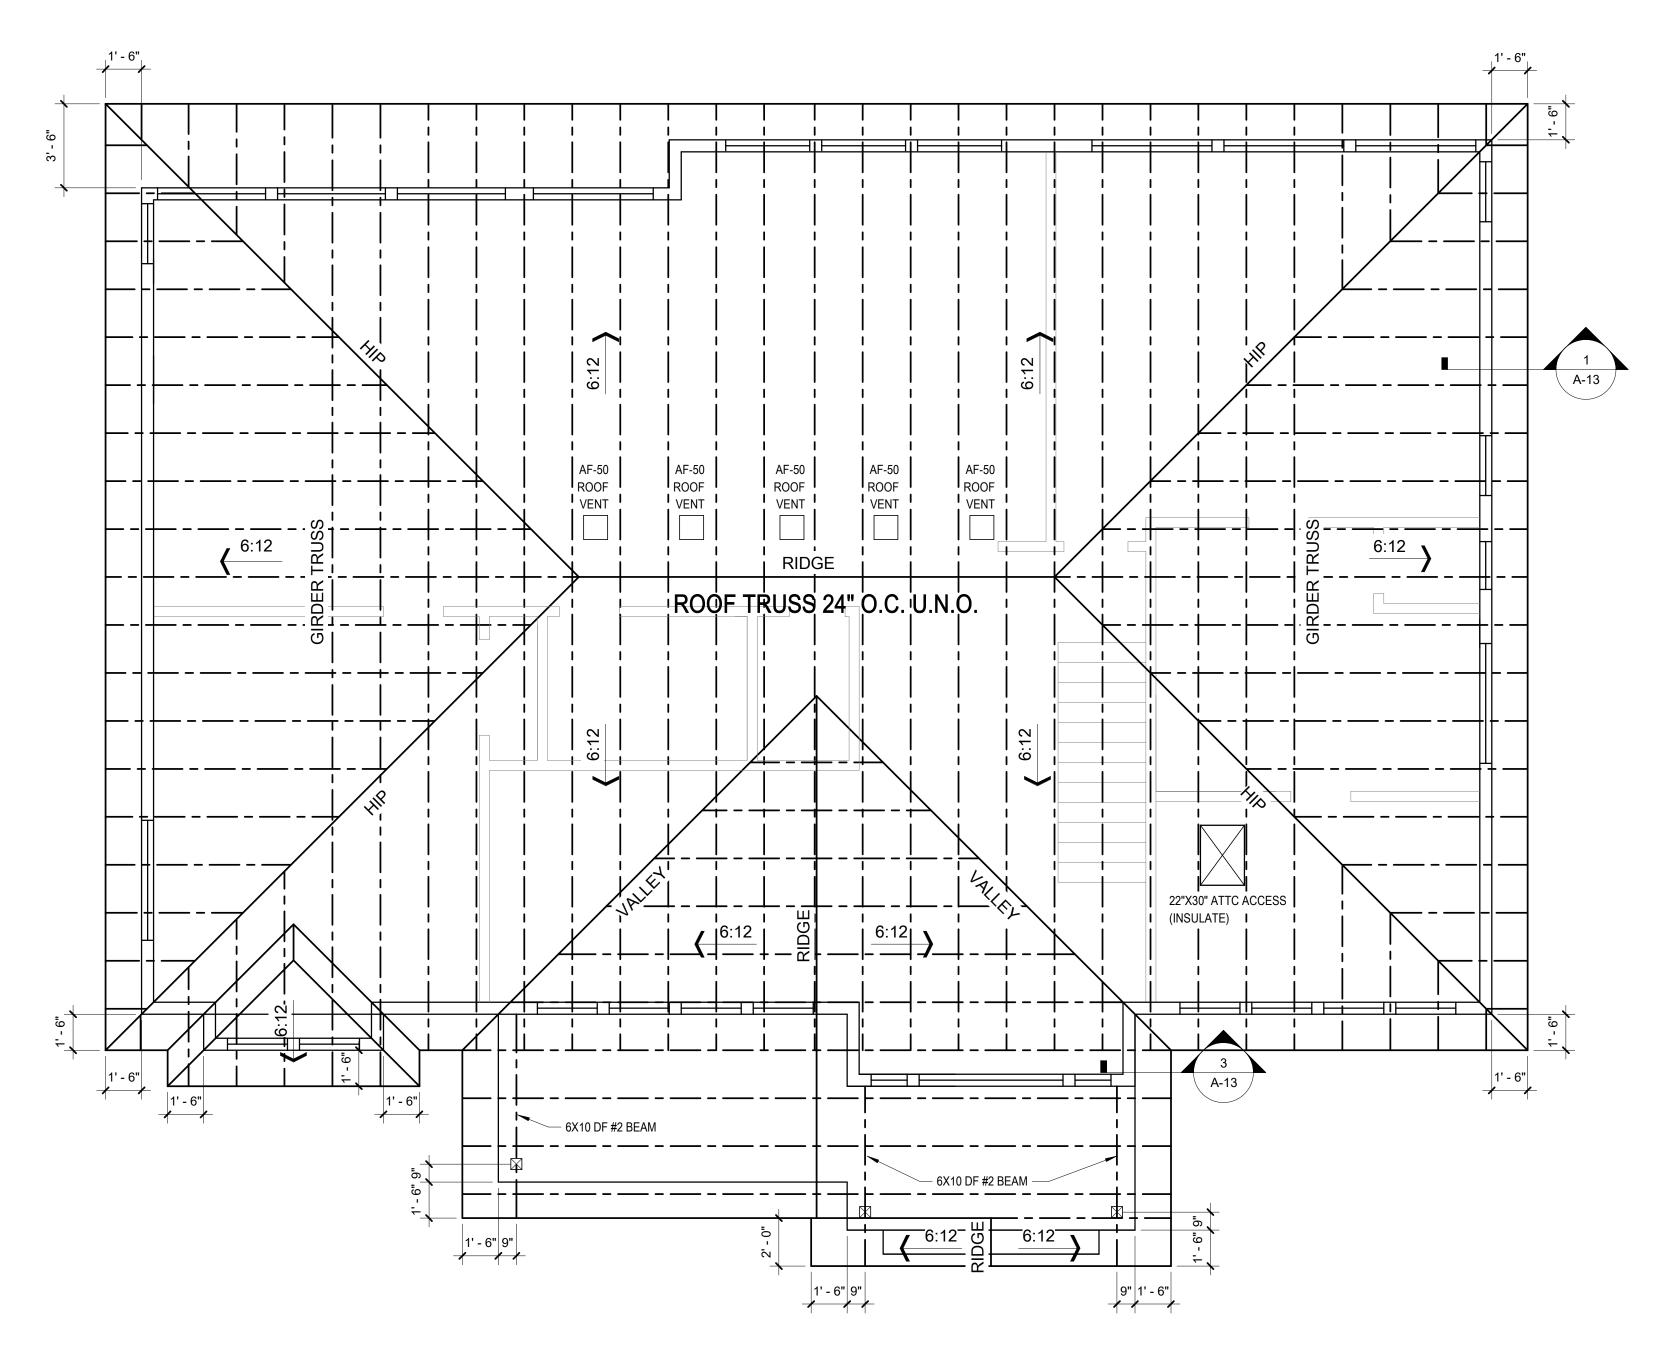

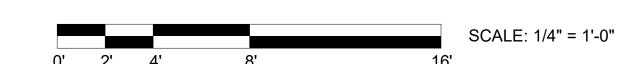



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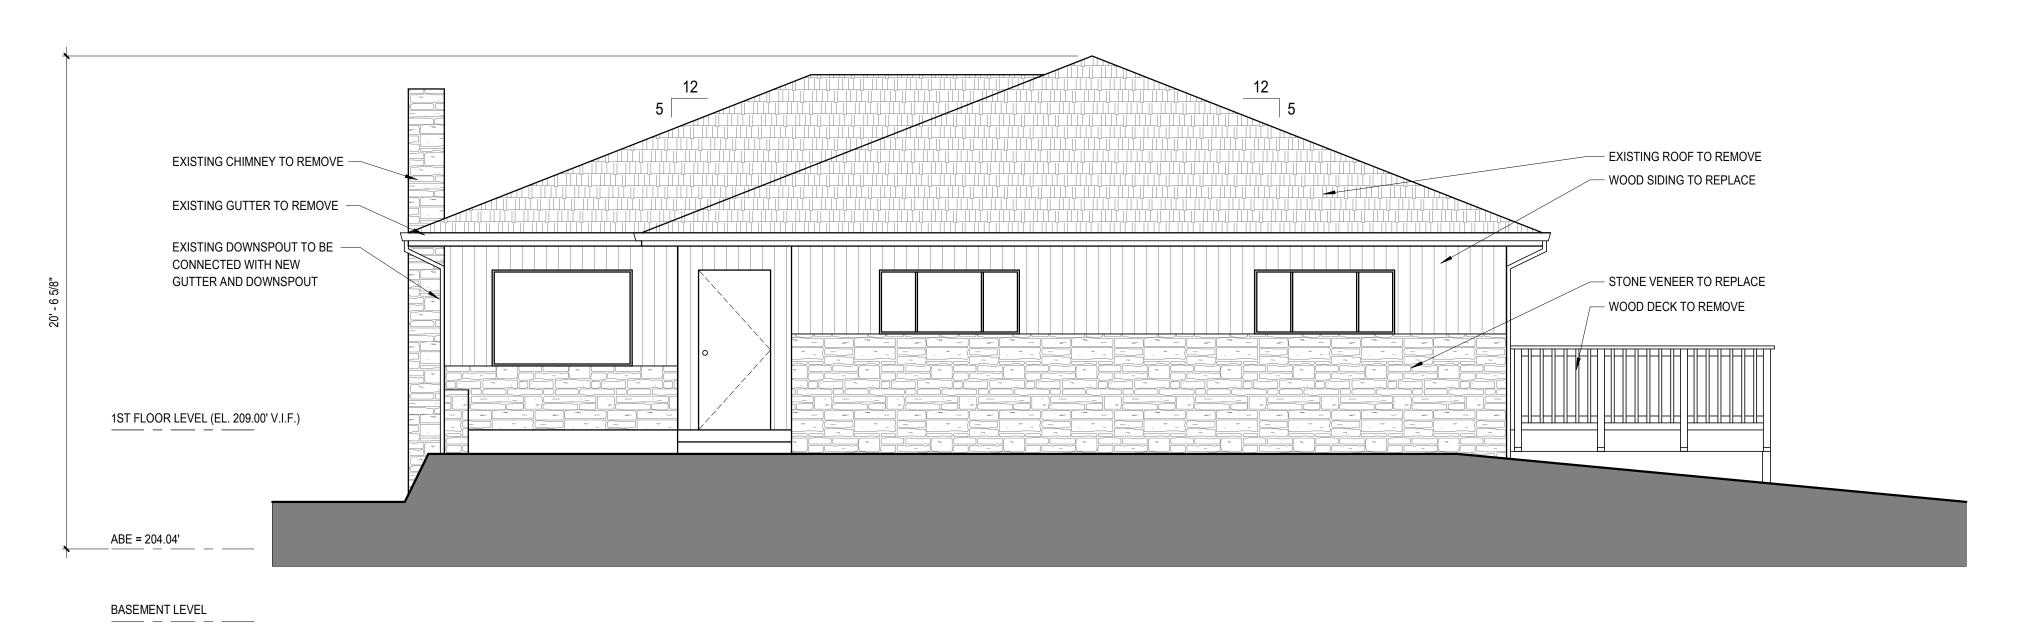
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**ROOF FRAMING PLAN** 



1. SEE SHEET A-1 FOR AVERAGE BUILDING ELEVATION CALCULATION. 2. SEE SHEET A-14 FOR WINDOW SCHEDULE

**BUILDING ELEVATION SOUTH - EXISTING** 



**WINDOW LEGEND NEW WINDOW EXISTING WINDOW** 

SEE SHEET A-1 FOR AVERAGE BUILDING ELEVATION CALCULATION.
 SEE SHEET A-14 FOR WINDOW SCHEDULE

**BUILDING ELEVATION SOUTH - PROPOSED** 

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PARK'S RESIDENCE **ADDITION** 

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BUILDING **ELEVATIONS -**SOUTH

NOT

1. SEE SHEET A-1 FOR AVERAGE BUILDING ELEVATION CALCULATION. 2. SEE SHEET A-14 FOR WINDOW SCHEDULE

1 BUILDING ELEVATION EAST - EXISTING



WINDOW LEGEND

NEW WINDOW

EXISTING WINDOW

NOTE:

1. SEE SHEET A-1 FOR AVERAGE BUILDING ELEVATION CALCULATION. 2. SEE SHEET A-14 FOR WINDOW SCHEDULE

BUILDING ELEVATION EAST - PROPOSED

1/4" = 1'-0"

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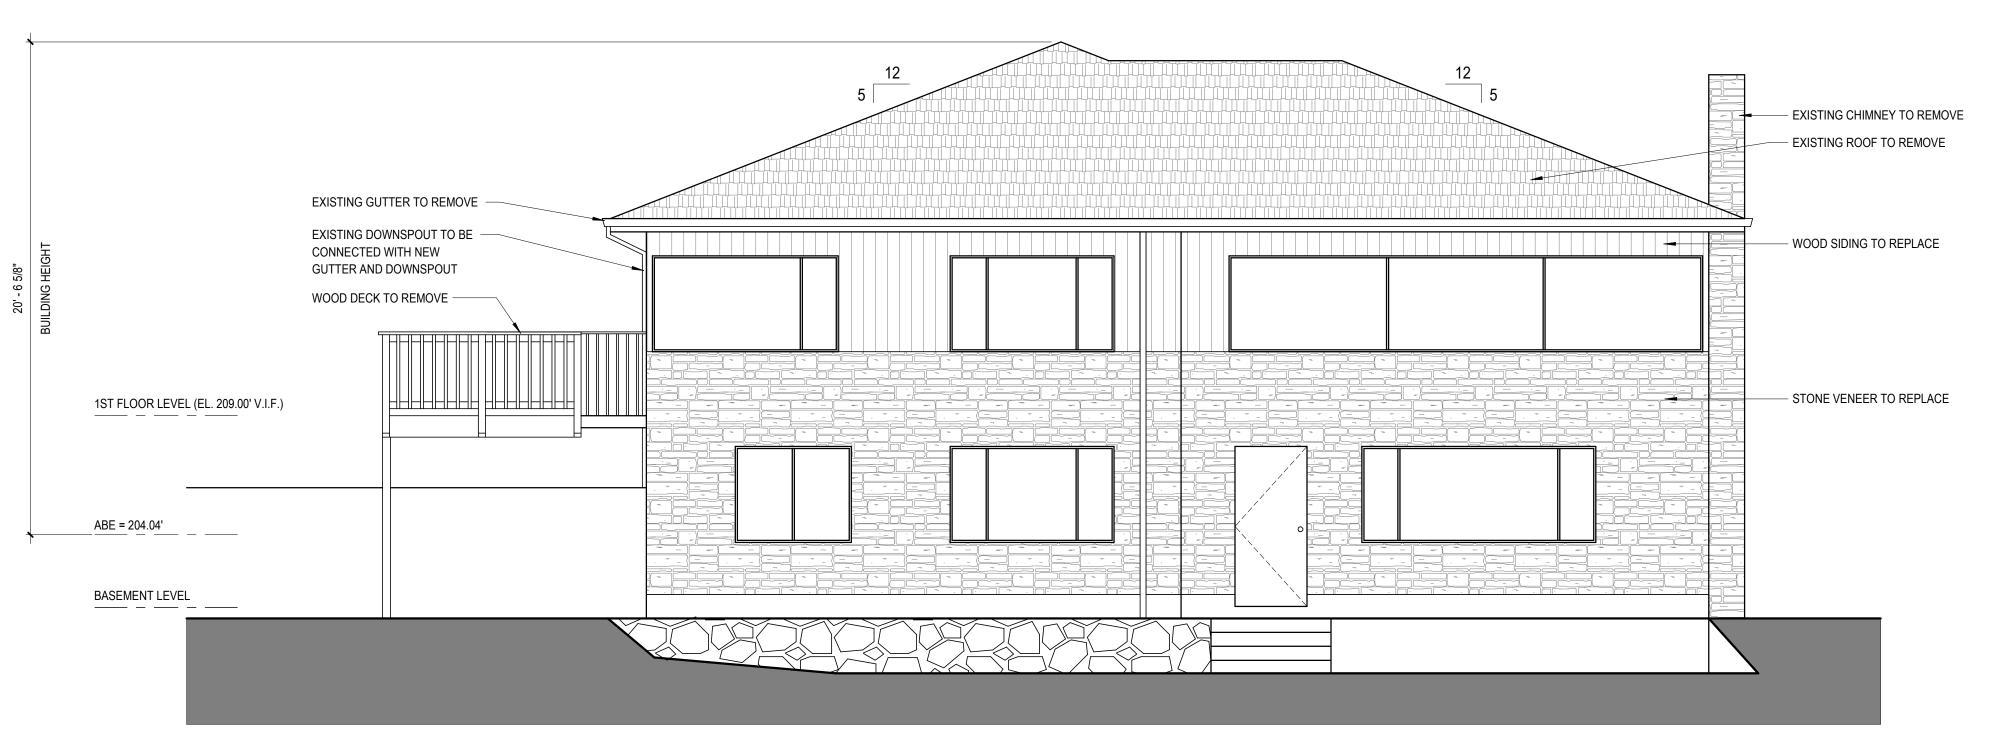
DWC

BUILDING ELEVATIONS -EAST

DWG.

A-10

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SEE SHEET A-1 FOR AVERAGE BUILDING ELEVATION CALCULATION.
 SEE SHEET A-14 FOR WINDOW SCHEDULE

**BUILDING ELEVATION NORTH - EXISTING** 



**WINDOW LEGEND NEW WINDOW EXISTING WINDOW** 

SEE SHEET A-1 FOR AVERAGE BUILDING ELEVATION CALCULATION.
 SEE SHEET A-14 FOR WINDOW SCHEDULE

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OWNER: **TAE PARK** 

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PARK'S

RESIDENCE

**ADDITION** 

8244 SE 30TH ST MERCER ISLAND WA 98040

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BUILDING **ELEVATIONS -**NORTH

A-11

BUILDING ELEVATION NORTH - PROPOSED


1/4" = 1'-0"

NOTE

1. SEE SHEET A-1 FOR AVERAGE BUILDING ELEVATION CALCULATION. 2. SEE SHEET A-14 FOR WINDOW SCHEDULE

BUILDING ELEVATION WEST - EXISTING

1/4" = 1'-0"

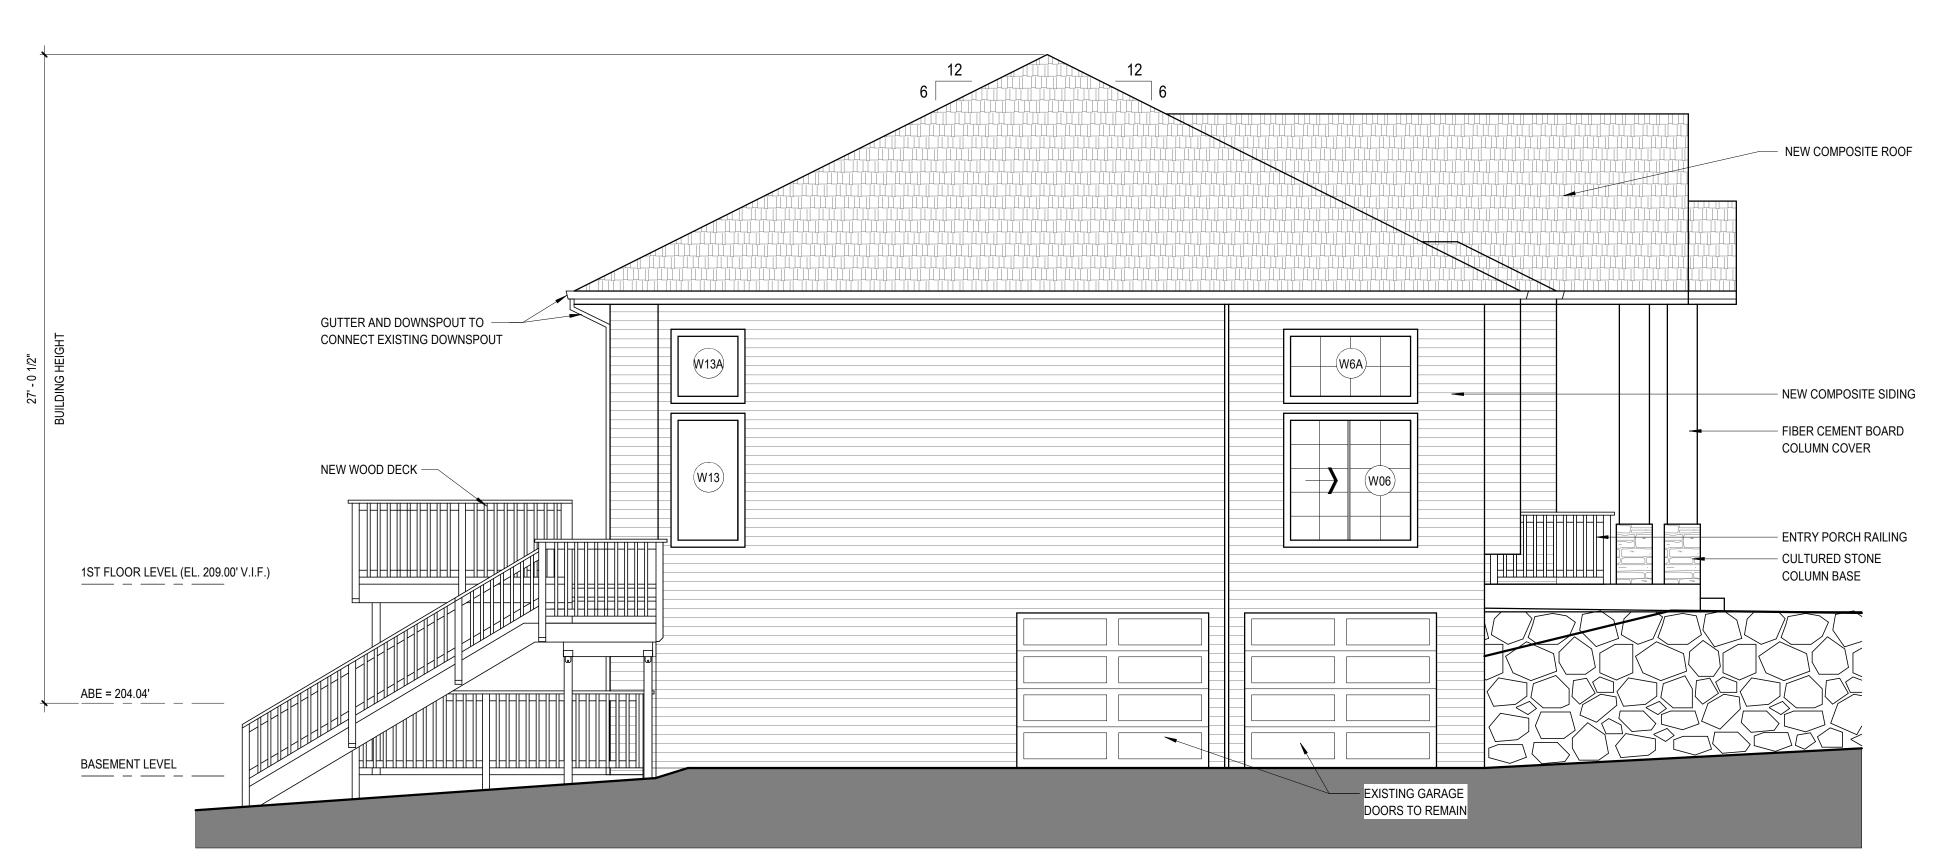

WINDOW LEGEND

NEW WINDOW

EXISTING WINDOW

NOTE:

1. SEE SHEET A-1 FOR AVERAGE BUILDING ELEVATION CALCULATION. 2. SEE SHEET A-14 FOR WINDOW SCHEDULE

BUILDING ELEVATION WEST - PROPOSED

1/4" = 1'-0"

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SEKWANG JOO STATE OF WASHINGTON

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DATE: **08/27/19** 


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BUILDING ELEVATIONS -WEST

VG.

A-12

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1. VINYL FRAME WINDOWS, JELD-WEN V-4500 SERIES, INSULATED LOW-E CLEAR FLOAT, DOUBLE PANE, AIR FILLED, FRAME COLOR: WHITE, TARGET U-VALUE < 0.3 SEE 7,8 AND 9 / A-16 FOR WINDOW DETAILS

-. ONE OR MORE WALKING SURFACES ARE WITHIN 36 INCHES, MEASURED HORIZONTALLY AND IN A STRAIGHT LINE

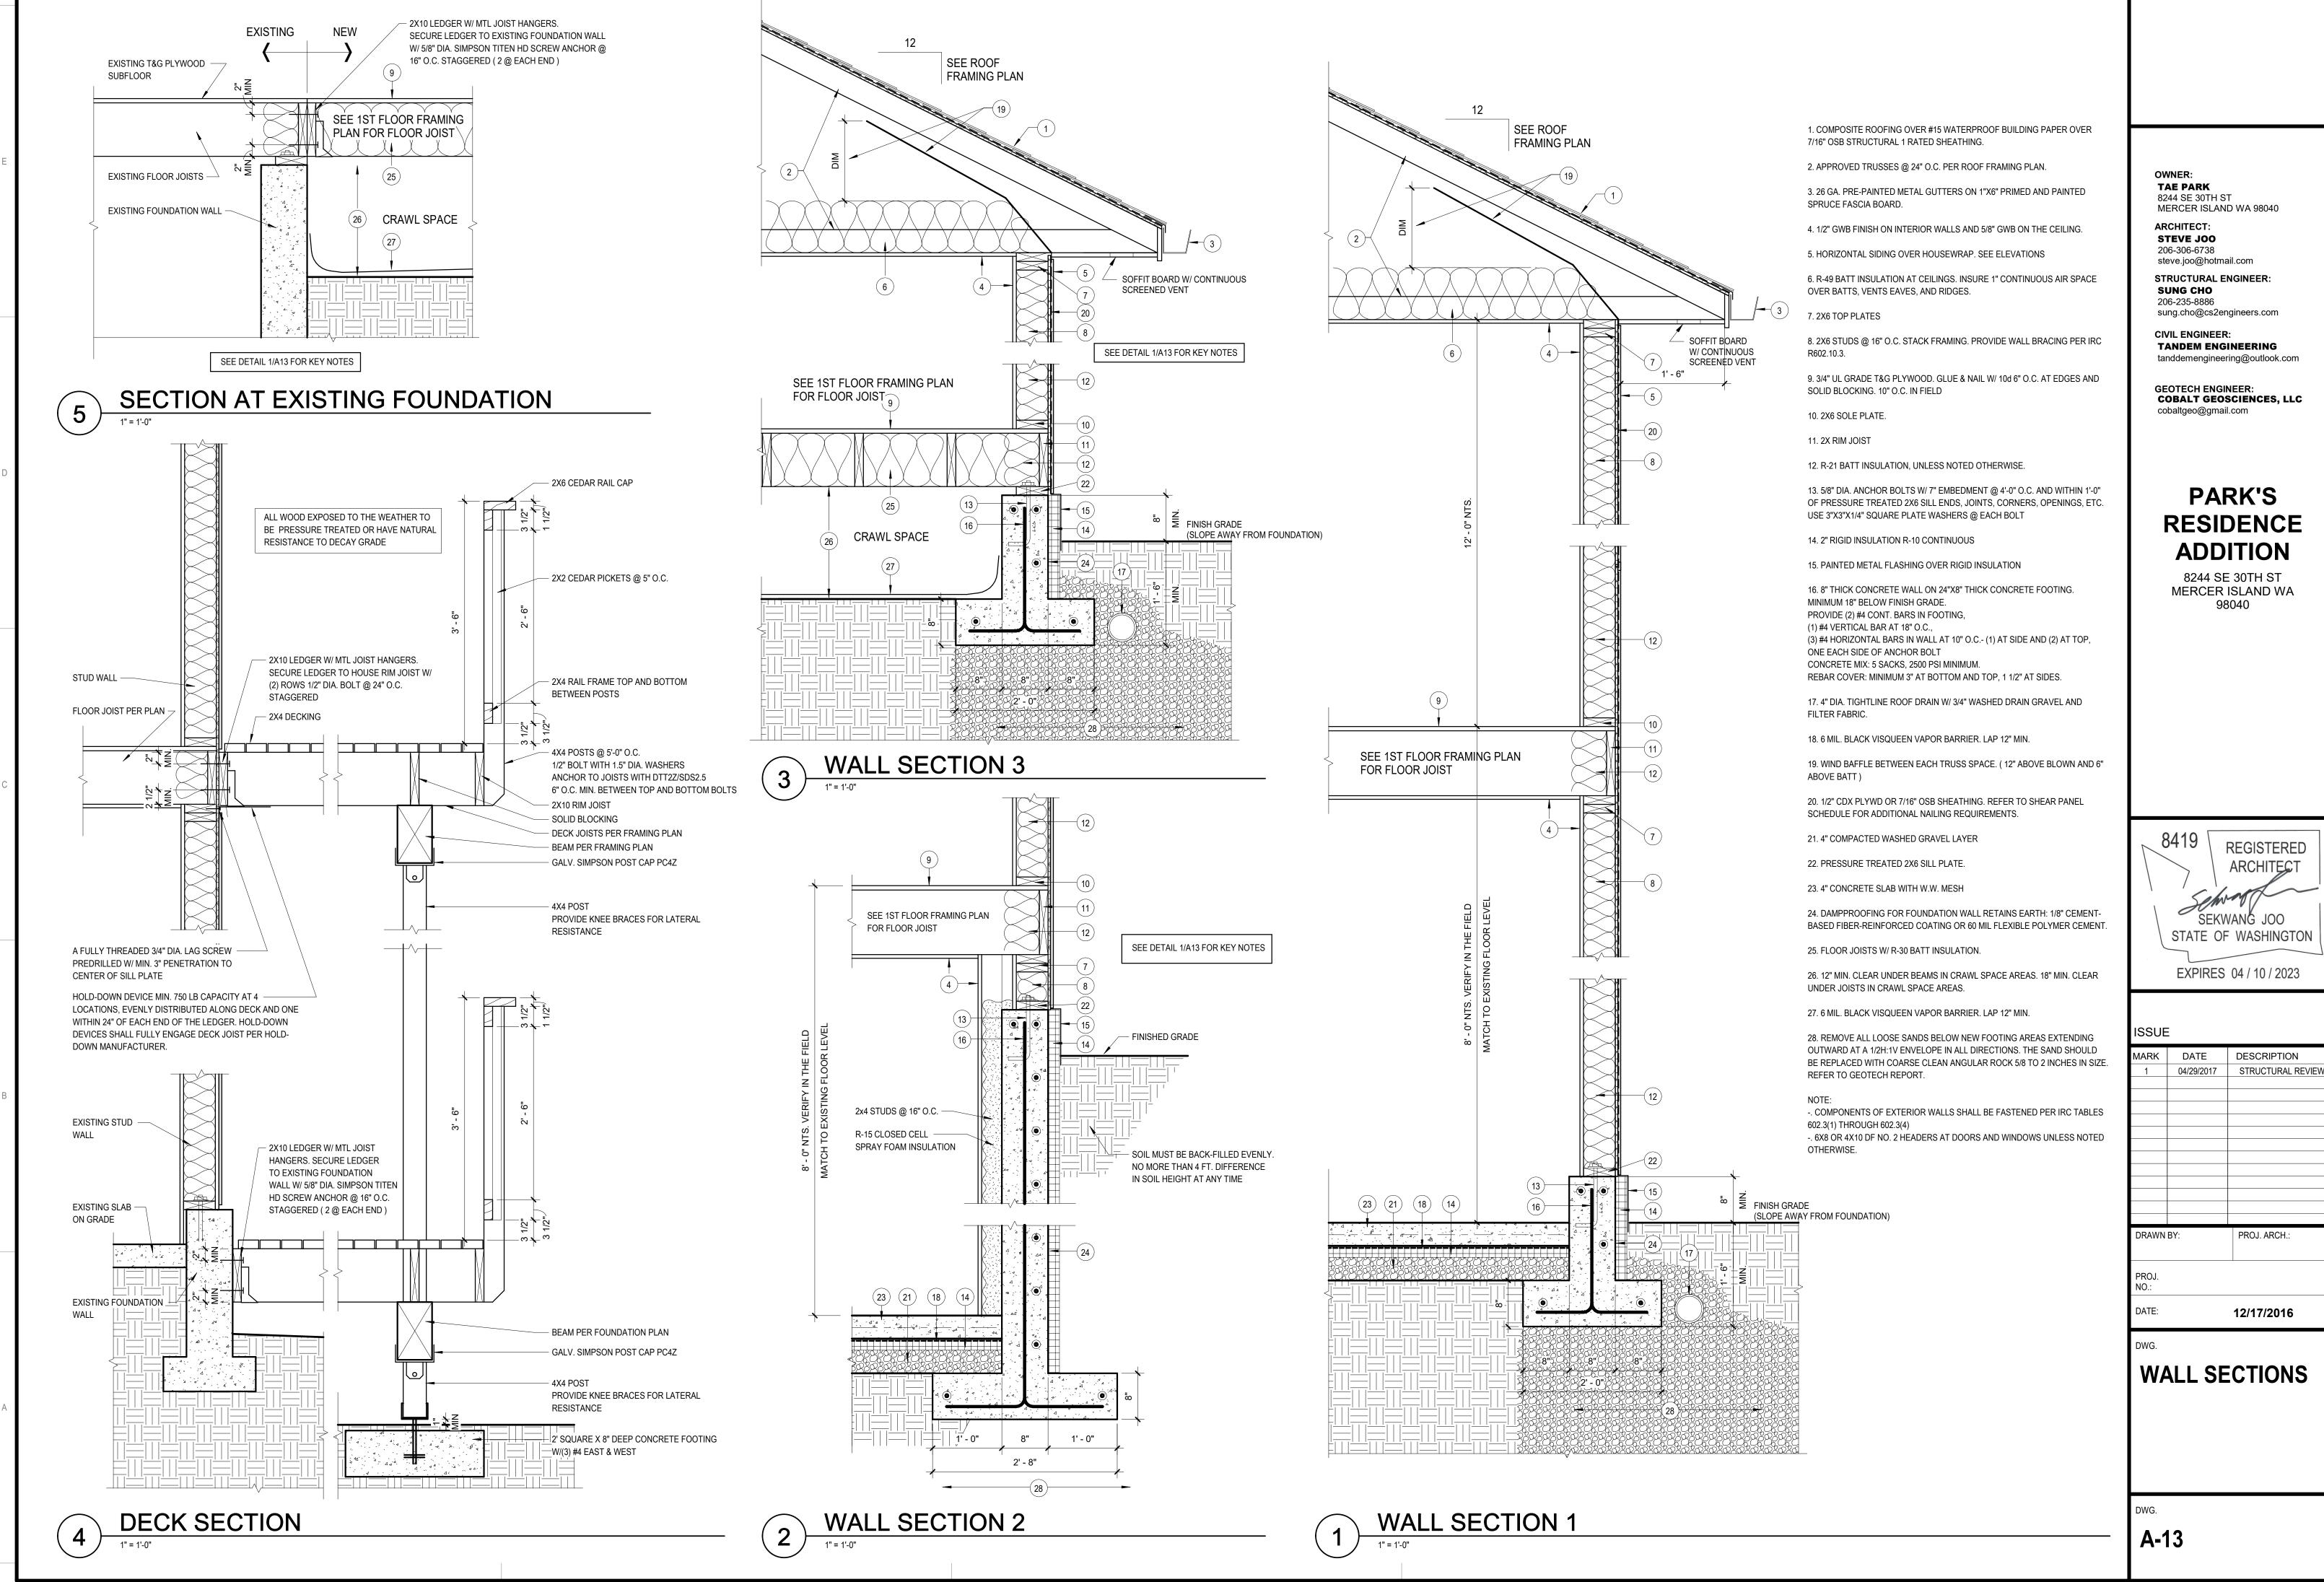
2. TEMPERED GLASS REQUIREMENT: PER IRC R308.4.3 GLAZING IN WINDOWS, GLAZING IN AN INDIVIDUAL FIXED OR OPERABLE PANEL THAT MEETS ALL OF THE FOLLOWING CONDITIONS SHALL BE CONSIDERED TO BE A HAZARDOUS LOCATION.

-. THE EXPOSED AREA OF AN INDIVIDUAL PANE IS LARGER THAN 9 SQUARE FEET, AND

-. THE BOTTOM EDGE OF THE GLAZING IS LESS THAN 18 INCHES ABOVE THE FLOOR, AND

- THE TOP EDGE OF THE GLAZING IS MORE THAN 36 INCHES ABOVE THE FLOOR, AND

**WINDOW SCHEDULE** 

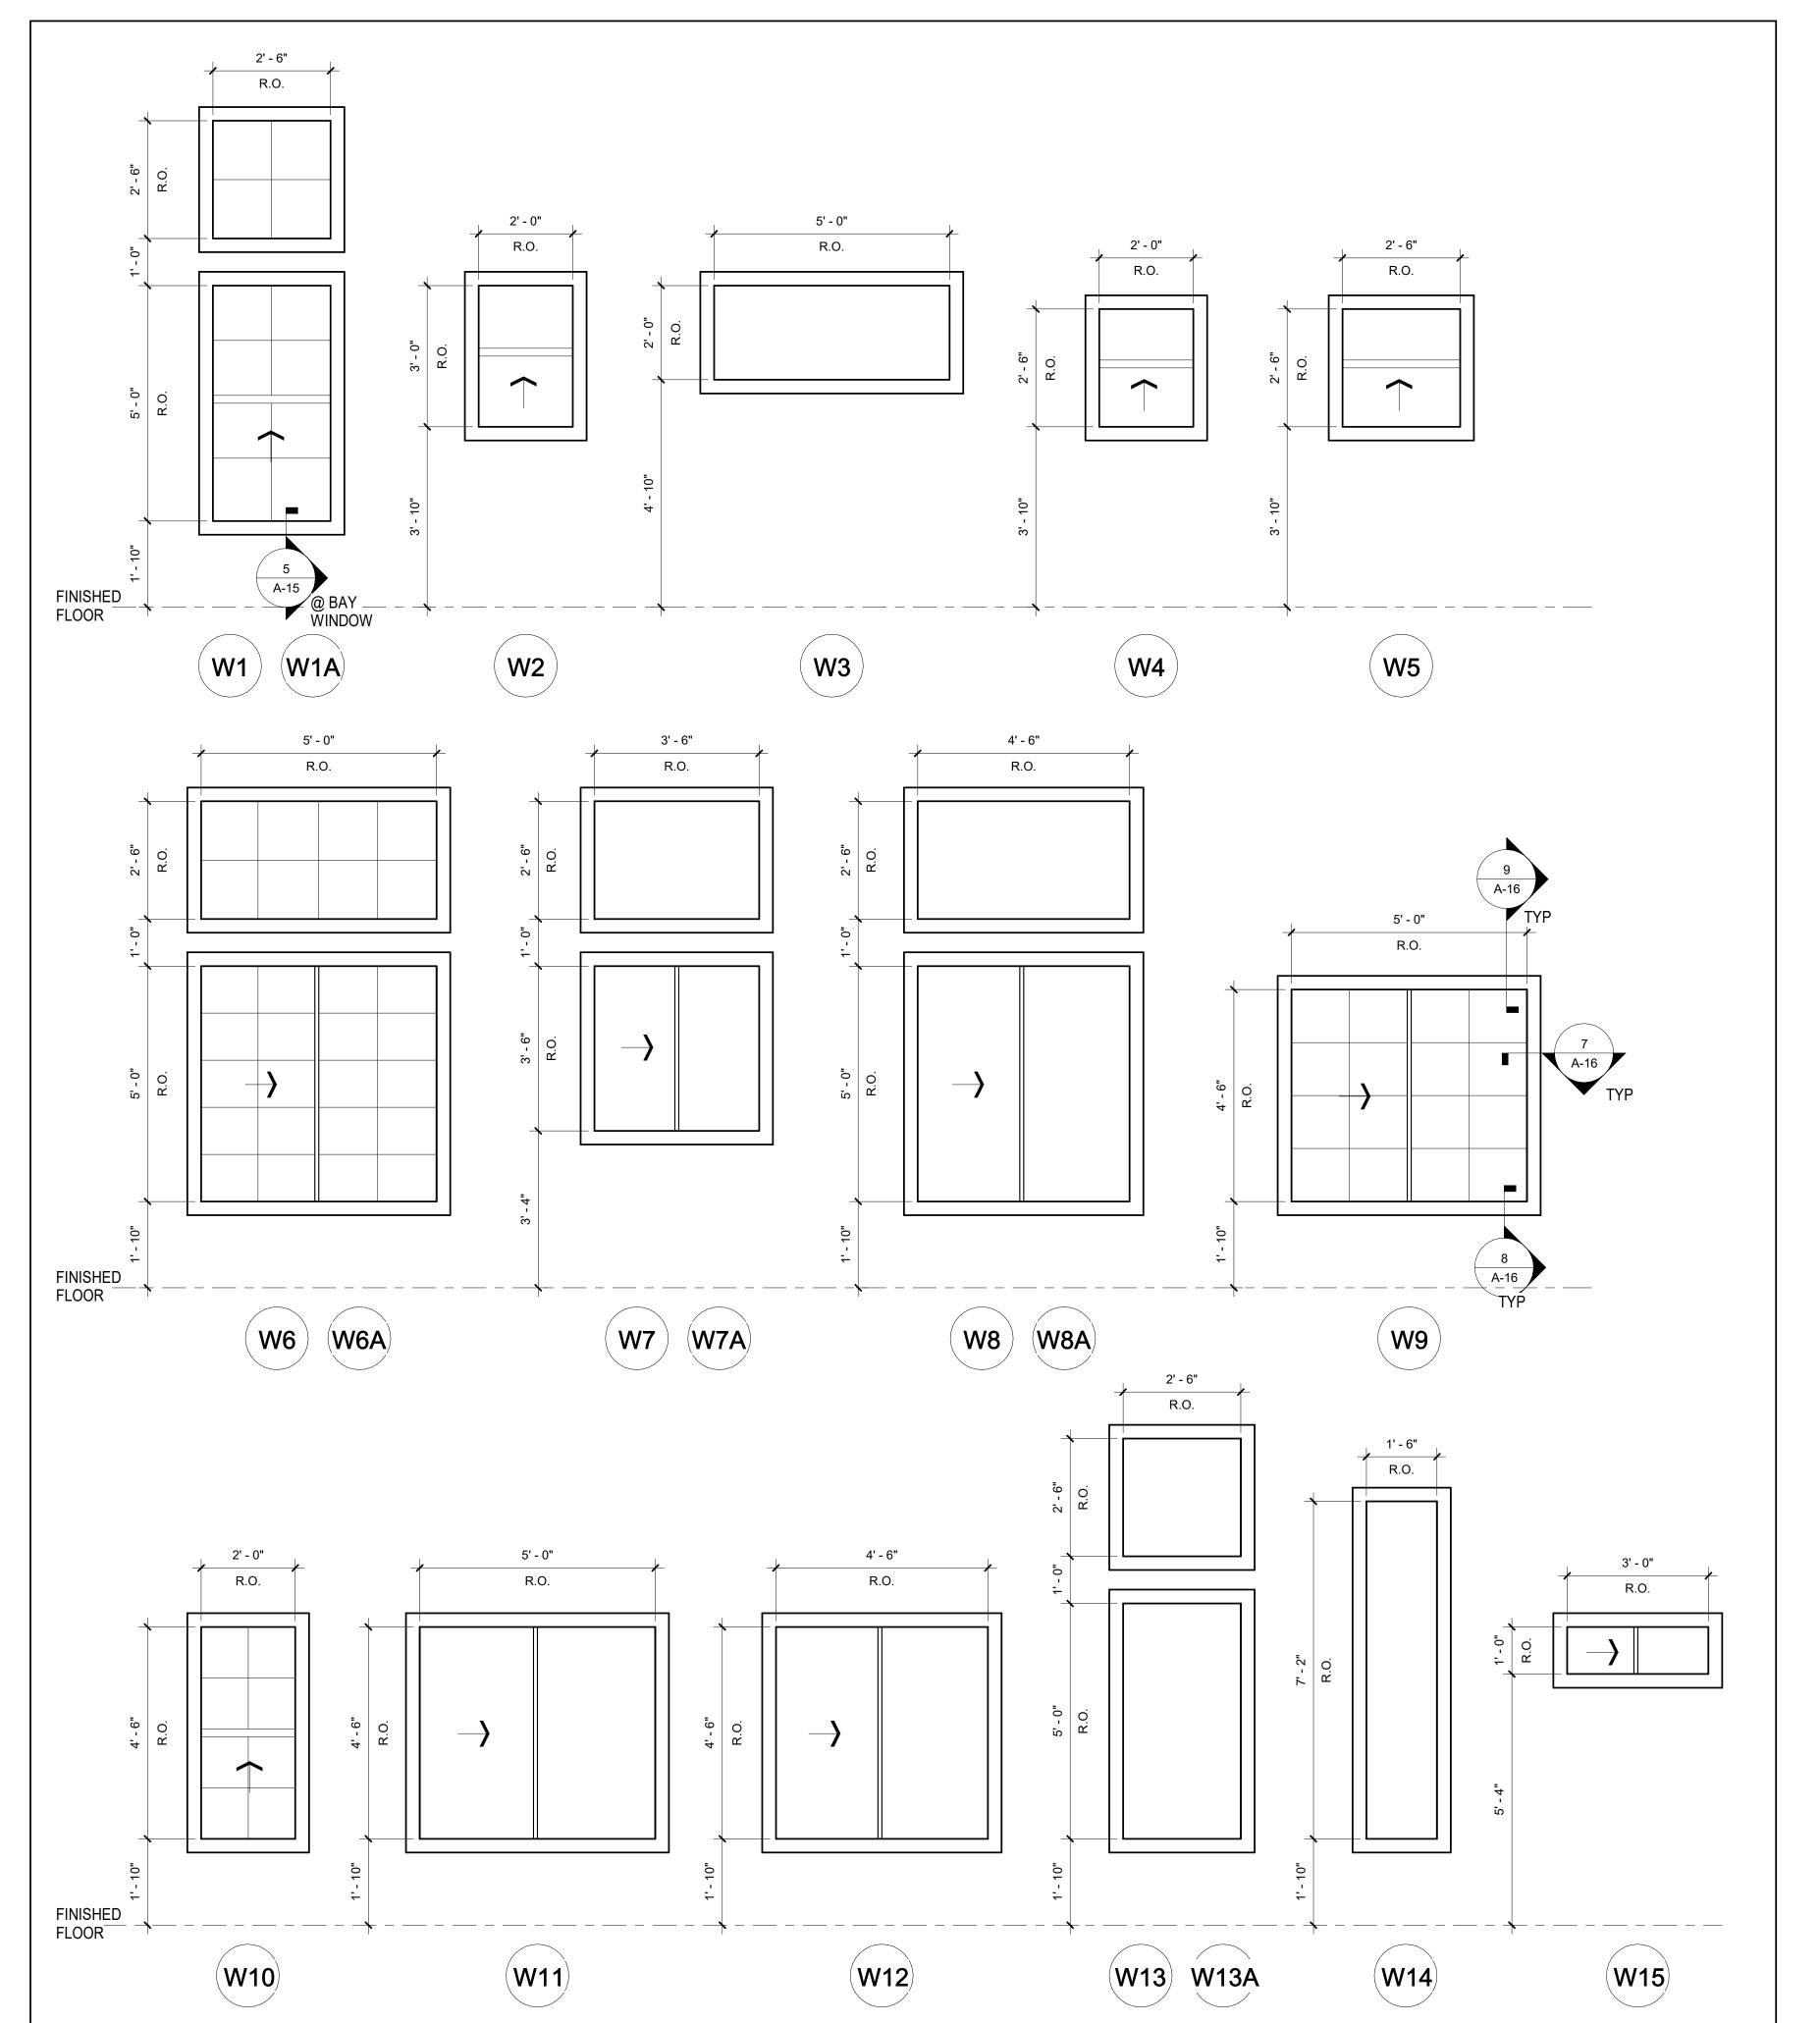

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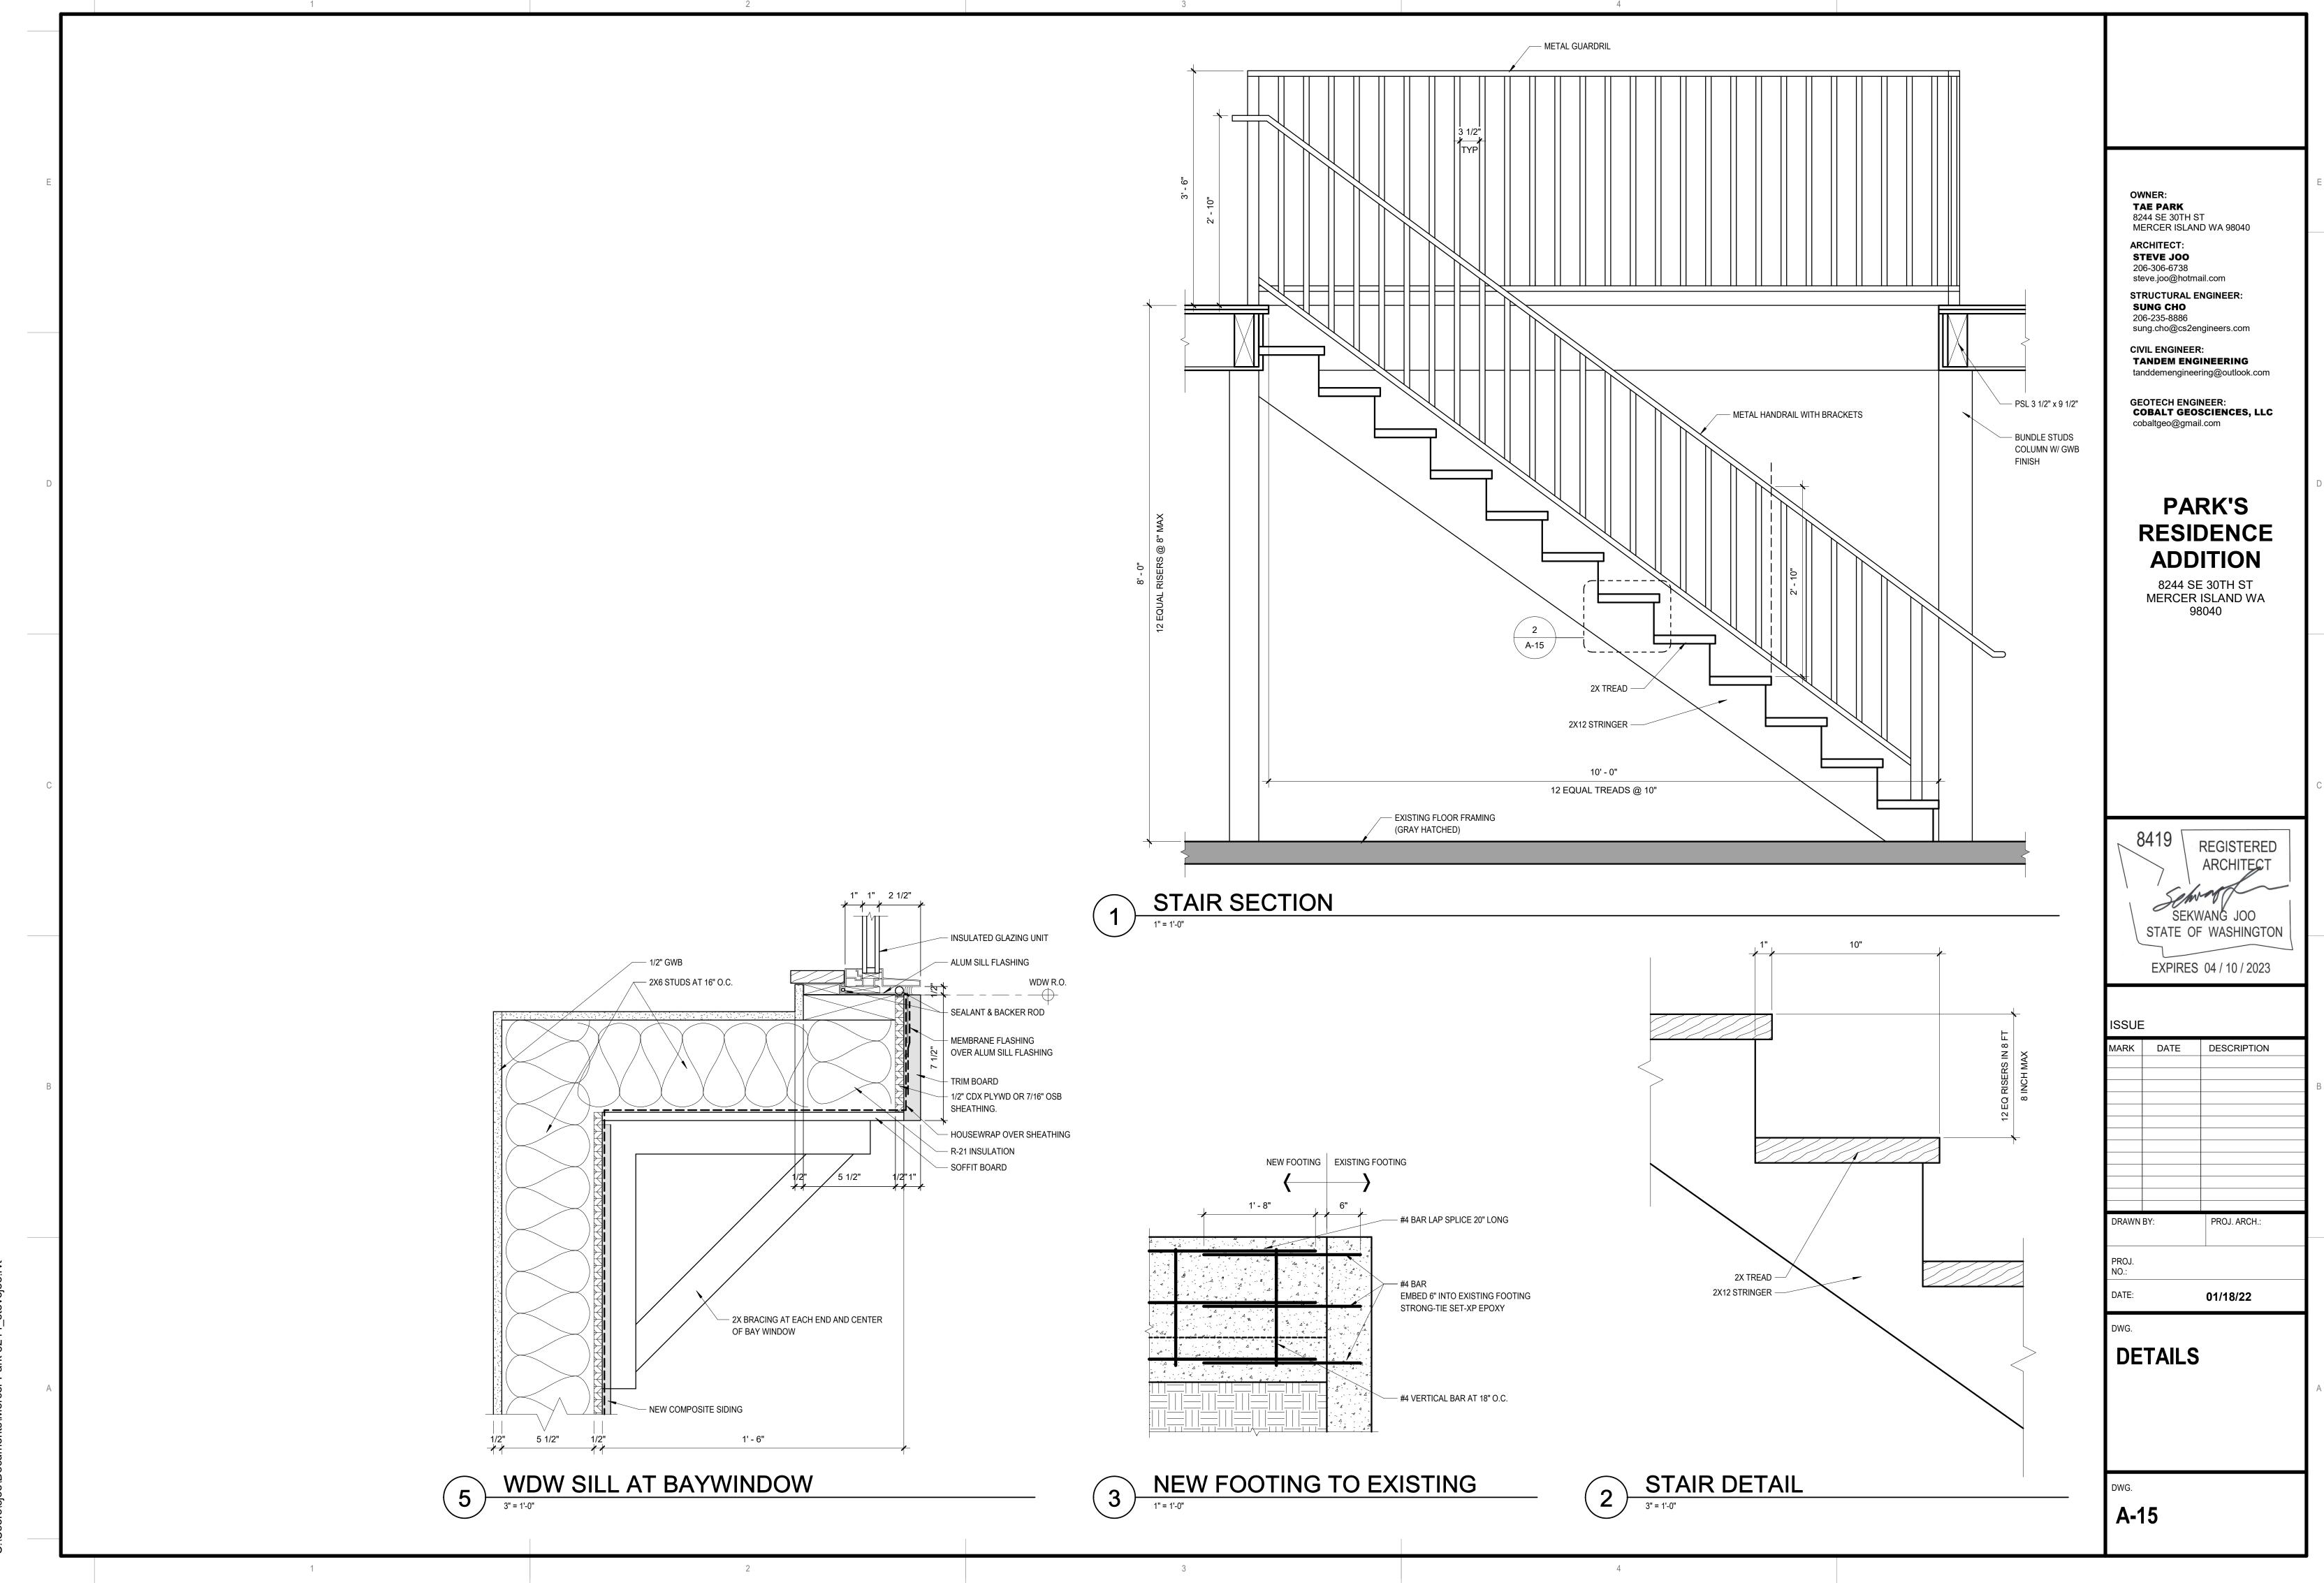
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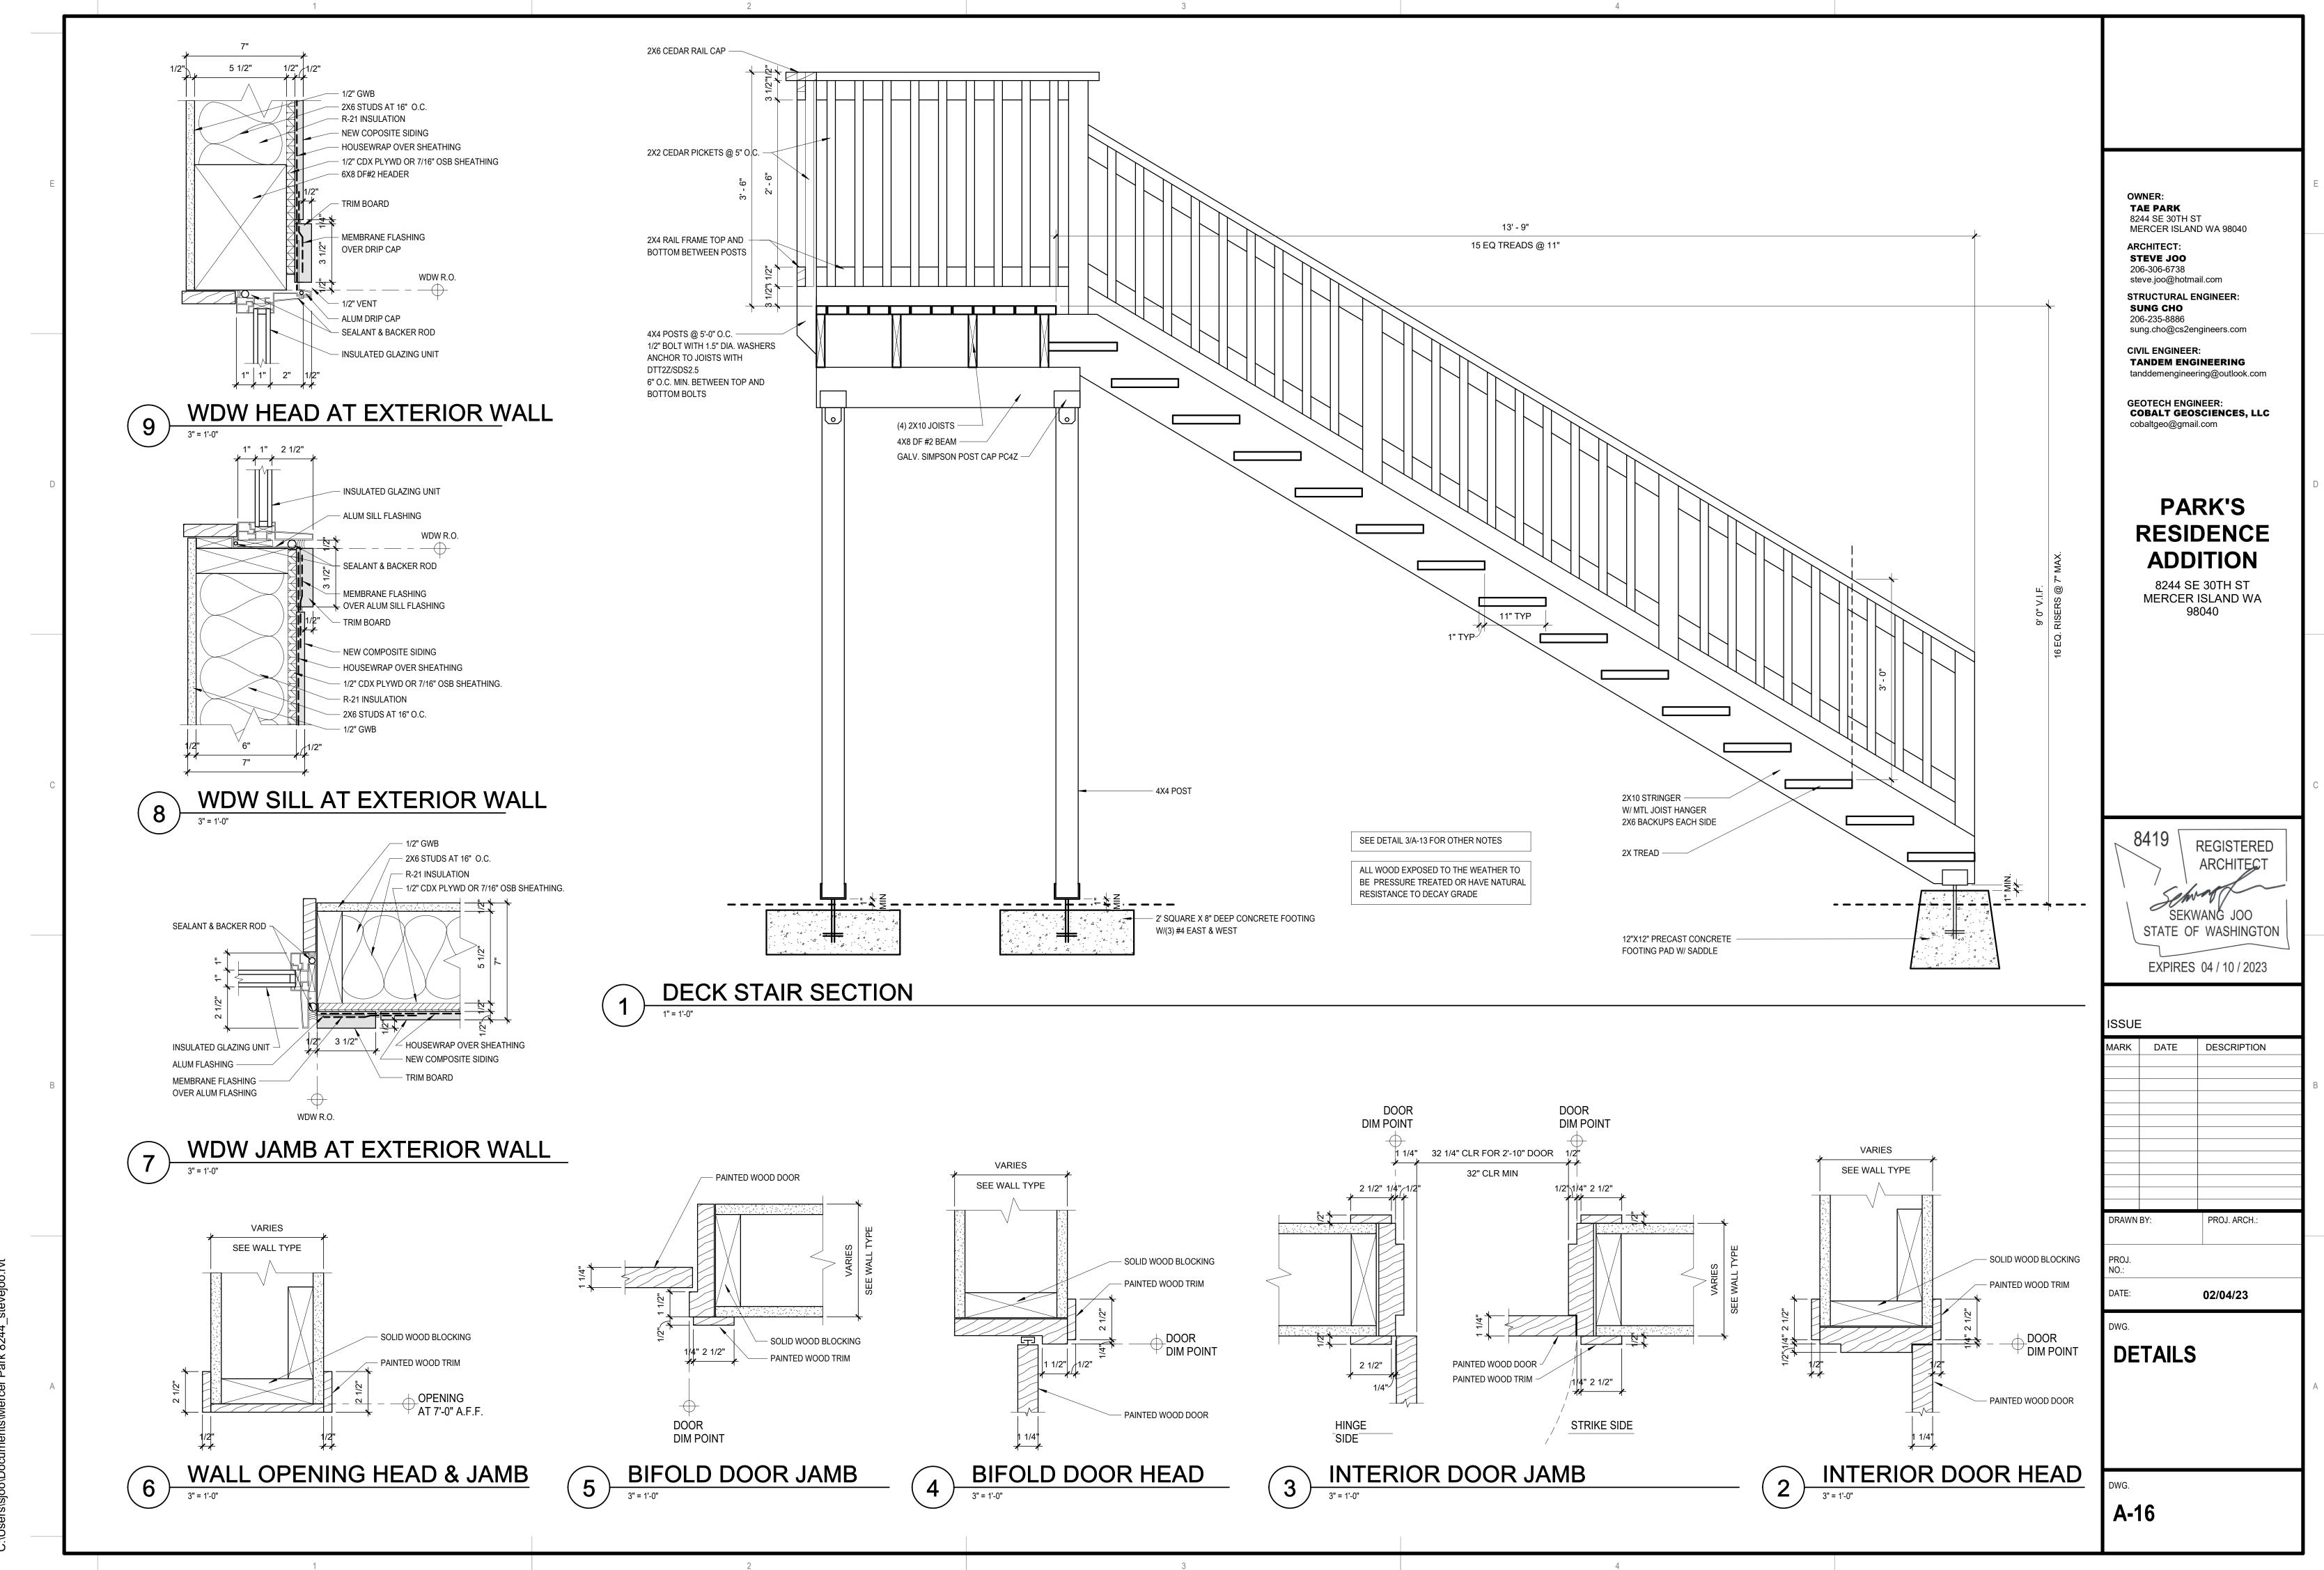
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DETAILS



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